## SYMPHONY PARK





City of Las Vegas
Newland Communities

# LAS VEGAS, NEVADA SCHEMATIC STREETSCAPE DESIGN

ORIGINAL PACKAGE - JULY 6, 2007 FINAL PACKAGE - AUGUST 7, 2007 REVISED PACKAGE - JUNE 5, 2009

**DESIGN**WORKSHOP, INC. KIMLEY-HORN & ASSOC.

FURNISHINGS.

- 2. SCHEMATIC DESIGN HAS BEEN COMPLETED FOR ALL STREETSCAPES WITHIN THE SIXTY-ONE ACRE SYMPHONY PARK. SCHEMATIC DESIGN HAS BEEN COMPLETED IN ORDER TO ACCOMPLISH THE FOLLOWING OBJECTIVES:
- A. UPHOLD THE OVERALL VISION ESTABLISHED BY NEWLAND COMMUNITIES AND THE CITY OF LAS VEGAS TO DEVELOP A SUSTAINABLE URBAN COMMUNITY;
- B. ESTABLISH A UNIFIED AND CONTINUOUS STREETSCAPE LAYOUT, REGARDLESS OF PROJECT PHASING BY INDIVIDUAL DEVELOPERS;
- C. ESTABLISH A CONSISTENT LEVEL OF QUALITY THROUGHOUT THE DEVELOPMENT; D. ESTABLISH A CONSISTENT APPLICATION OF STREETSCAPE COMPONENTS AND
- 3. SCHEMATIC DESIGN INCLUDES A NUMBER OF FIXED STREETSCAPE DESIGN DECISIONS

THAT ARE REQUIRED BY ALL DEVELOPERS. THESE ITEMS ARE LISTED BELOW:

- A. GENERAL COMMITMENT TO SUSTAINABILITY INTENTIONS, AS DEFINED WITH THE
- SYMPHONY PARK DESIGN STANDARDS; B. DIMENSIONED LAYOUT OF PRIMARY STREETSCAPE COMPONENTS, INCLUDING
- TREES, LIGHTS AND PAVING MODULES;
- C. PAVEMENT MATERIALS AND FINISHES, INCLUDING CAST-IN-PLACE CONCRETE, CONCRETE UNIT PAVERS, STONE PAVERS AND SPECIALTY ASPHALT PAVING;
- D. STANDARD PEDESTRIAN HANDICAP RAMPS AS DEFINED WITHIN SYMPHONY PARK INFRASTRUCTURE DOCUMENTS PREPARED BY KIMLEY HORN;
- E. SPECIFIED STREET LIGHTS AND LOCATIONS AND SPECIFIED SIGNAL POLE AND LOCATIONS AS DEFINED WITHIN SYMPHONY PARK INFRASTRUCTURE
- DOCUMENTS PREPARED BY KIMLEY HORN; F. MINIMUM PERCENTAGES OF SPECIAL PAVING AS DEFINED WITH THE SYPMHONY
- PARK DESIGN STANDARDS; G. SITE FURNITURE AS SPECIFIED; WITH OPPORTUNITIES FOR ART.
- H. DETAILED INTENT FOR LANDSCAPE PANELS, INCLUDING EDGE DESIGN;
- SPECIFIED SITE PEDESTRIAN LIGHTING;
- J. SPECIFIED TREES AND OTHER PLANT SPECIES DEFINED AS ALTERNATIVES
- WITHIN THESE DOCUMENTS; K. SPECIFIED MINIMUM REQUIREMENTS FOR TREE SIZES,
- L. MINIMUM REQUIREMENTS FOR SHADE COVER AS DEFINED WITH THE SYMPHONY PARK DESIĞN STANDARDS;
- M. STREETSCAPE DESIGN GRADING INTENT, INCLUDING MINIMUM REQUIREMENT FOR 12" VERTICAL SEPARATION BETWEEN BUILDING FINISHED FLOOR ELEVATION AND ASSOCIATED FLOW LINE, AS ESTABLISHED BY THE CITY OF LAS VEGAS.
- 4. SCHEMATIC DESIGN INCLUDES A NUMBER OF FLEXIBLE DESIGN OPPORTUNITIES THAT ARE EXPECTED OF ALL DEVELOPERS. WHILE FLEXIBLE, SCHEMATIC DESIGN INTENT IS REPRESENTED WITHIN THESE DOCUMENTS. THESE ITEMS ARE LISTED BELOW:
  - A. DETAILED APPLICATION OF SUSTAINABILITY INTENTIONS AS DEFINED WITH THE
  - SYMPHONY PARK DESIGN STANDARDS; B. SPECIFIC ARRANGEMENT OF FURNITURE ALONG STREETSCAPE;
  - C. OPPORTUNITIES FOR ART, DEFINED WITHIN THESE DOCUMENTS ONLY BY
- GENERAL TYPE AND LOCATION; D. DETAILED LOCATIONS FOR BUILDING-BASED UTILITIES, DEFINED WITHIN THESE
- DOCUMENTS BY ALLOWABLE ZONE ONLY; E. SPECIFIC LOCATIONS FOR PARCEL VEHICULAR ACCESS, DEFINED WITHIN THE SYMPHONY PARK DESIGN STANDARDS IN TERMS OF GENERAL LOCATION AND
- WITHIN THESE STANDARDS; F. OPPORTUNITIES FOR ARCHITECTURAL SHADE STRUCTURES AS DEFINED WITHIN THE SYMPHONY PARK DESIGN STANDARDS AS PART OF THE SOLAR ANALYSIS
- AND INTENSE HEAT ZONE DEFINITION; G. DESIGN DEVELOPMENT AND CONSTRUCTION DOCUMENTATION FOR THESE
- 5. ALL LIGHTING, EXCEPT CENTENNIAL STREET LIGHTS, SHALL BE PRIVATELY MAINTAINED

#### **EXISTING CONDITIONS NOTES**

STREETSCAPES.

- 1. PUBLIC STREET R.O.W. (BACK OF CURB TO BACK OF CURB) WILL BE BUILT BY OTHERS.
- 2. CURB AND GUTTER WILL BE BUILT BY OTHERS AT PROPERTY LINE.
- 3. PARKING POCKETS WILL BE BUILT BY BLOCK DEVELOPER AS PART OF THEIR CONSTRUCTION THEN DEDICATED BACK TO THE CITY OF LAS VEGAS.
- 4. PUBLIC UTILITIES HAVE BEEN COORDINATED. PARCEL DEVELOPERS WILL ACCOMMODATE UTILITY COMPONENTS WITHIN THEIR STREETSCAPES, EITHER UNDERGROUND, INSIDE BUILDING, OR IN AN AREA NOT VISIBLE FROM THE STREET.
- 5. OVER LOT GRADES WILL BE DEFINED AS PART OF THE PUBLIC STREET CONSTRUCTION. CURB ELEVATIONS HAVE BEEN DEFINED WITH PUBLIC STREETS. STREETSCAPE CROSS-SLOPES HAVE BEEN DEFINED WITHIN THESE DOCUMENTS, RESULTING IN
- GENERAL REQUIREMENTS FOR BUILDING PAD ELEVATIONS. 6. STREET LIGHT LOCATIONS HAVE BEEN DEFINED BY THE CIVIL ENGINEER AND SHOULD
- LAND ON THE STREETSCAPE MODULE OUTLINED IN THE LAYOUT NOTES BELOW. 7. BRT STATION ON GRAND CENTRAL PARKWAY WILL BE BUILT BY OTHERS.

#### PLANTING NOTES

- 1. USE SINGLE STREET TREE SPECIES PER STREET (BOTH SIDES). SEE PLANT MATRIX ON SHEET L2-01.
- 2. DECIDUOUS STREET TREES WILL BE 60" BOX IN SIZE. LOWER MOST LIMB A MINIMUM OF 7' FROM FINISHED GRADE.
- 3. PLANT ALL DECIDUOUS STREET TREES IN TREE TRENCH. SEE DETAILS PL.1, PL.2, PL.3 FPR LOCATIONS OF STRUCTURAL SOIL.
- 4. PALMS WILL BE 22' CLEAR TRUNK IN SIZE.

#### **GRADING AND DRAINAGE NOTES**

- 1. FOR ROADWAY, GRADING, UTILITIES AND SPECIFICATIONS, REFER TO CIVIL DOCUMENTS.
- 2. ORIENT GRADING AND DRAINAGE TO ALLOW SIDEWALK STORMWATER TO ENTER LANDSCAPE PANEL. PROVIDE 2% CROSS-SLOPE TOWARD STREET.

#### **LAYOUT NOTES**

1. STREETSCAPES ARE LAID OUT ACCORDING TO A 2' MODULE PERPENDICULAR TO THE STREET CENTERLINE. THIS MODULE IS DERIVED FROM THE 24' SPACING OF THE STREET TREES AND THE 48' SPACING OF PEDESTRIAN LIGHTS. ALL ELEMENTS WITHIN THE STREETSCAPE (CURB CUTS, LANDSCAPE PANELS, SPECIAL PAVING, TREE GRATES, PLANTERS AND SCORE JOINTS) ARE LAID OUT ACCORDING TO 2' MULTIPLES OF 24' (2', 4', 6', 8', 10', 12', 14', 16', 18', 20', 22', 24'). EXCEPTIONS TO THIS SYSTEM ARE NOTED.

- 2. THE STREETSCAPE MODULE LAYOUT SYSTEM IS INITIATED AT THE CENTER POINT OF EACH BLOCK FACE. A "POINT OF BEGINNING" IS NOTED AT THIS POINT ON ALL STREETSCAPES. THE LAYOUT MODULE FLOWS IN BOTH DIRECTIONS FROM THIS POINT.
- 3. WRITTEN DIMENSIONS TAKE PRECEDENCE OVER SCALE. DO NOT SCALE DRAWINGS.
- 4. MEASUREMENTS ARE TO FINISHED FACE OF BUILDING, WALL OR THE FIXED SITE IMPROVEMENT.
- 5. INSTALL INTERSECTING ELEMENTS AT 90-DEGREE ANGLES TO EACH OTHER UNLESS OTHERWISE NOTED.
- 6. PROVIDE EXPANSION JOINTS WHERE CONCRETE FLATWORK MEETS VERTICAL

STRUCTURES, SUCH AS SEAT WALLS, CURBS, AND BUILDING ELEMENTS.


- 7. EXPANSION JOINTS IN STREETSCAPES SHALL BE LOCATED FIFTY FEET (50'-0") O.C.
- MAXIMUM, OR PER CITY OF LAS VEGAS STANDARDS, WHICHEVER IS LESS.
- 8. RETAIN 8' MINIMUM UNOBSTRUCTED PEDESTRIAN CIRCULATION ZONE. EXCEPTIONS TO THIS RULE ARE NOTED.
- 9. POTENTIAL ARCHITECTURAL TREATMENT AT PUBLIC INTERSECTIONS MAY BE ADDED BY COMMUNITY ASSOCIATION OR THE CITY OF LAS VEGAS AT A LATER DATE.
- 10. CENTER ALL PEDESTRIAN LIGHTS WITH ASSOCIATED PAVEMENT JOINTS.
- 11. CENTER ALL TRASH RECEPTACLES WITH ASSOCIATED PAVEMENT JOINTS.
- 12. ORIENT BENCHES PERPENDICULAR OR PARALLEL TO STREET CENTERLINE.
- 13. PROVIDE 30" MINIMUM CLEAR SPACE BETWEEN STREETSCAPE COMPONENTS.
- 14. PROVIDE 30" MINIMUM CLEAR SPACE BETWEEN EDGE OF STREETSCAPE COMPONENT AND FACE OF CURB.
- 15. ALIGN PAVEMENT JOINTING WITH CURB AND GUTTER JOINTING.
- 16. ALIGN CORNER OF SPECIAL PAVING, LANDSCAPE PANELS AND TREE GRATE
- WITH INTERSECTING SCORE JOINTS.
- 17. MAXIMIZE CAR PARKING SPACES. MOTORCYCLE PARKING SHOULD BE ADDED AT ENDS OF PARKING BAYS. DO NOT ADD SINGLE MOTORCYCLE PARKING SPACES. KEEP MOTORCYCLE PARKING TO TWO SPACES MAXIMUM.
- 18. ALL TREE GRATES FOR DECIDUOUS TREES TO BE 4' SQUARE. ALL TREE GRATES FOR PALMS NOT ON THE PROMENADE TO BE 6' SQUARE. ALL TREE GRATES FOR PALMS ON THE PROMENADE TO BE CUSTOM 4'X6' GRATES. PLEASE NOTE THAT SOME PALM TREE GRATES IN THIS PACKAGE ARE ILLUSTRATED IN ERROR AS 4' SQUARE. PLEASE REFER TO THE NOTES ABOVE FOR PROPER TREE GRATE SIZES.

#### SHEET INDEX

SHEET NO.	SHEET TITLE
L0-01	GENERAL INFORMATION
L1-01	PARCEL A1 SITE PLAN
L1-02	PARCEL A2 SITE PLAN
L1-03	PARCEL B (a) SITE PLAN
L1-04	PARCEL B (b) SITE PLAN
L1-05	PARCEL C (a) SITE PLAN
L1-06	PARCEL C (b) SITE PLAN
L1-07	PARCEL D SITE PLAN
L1-08	PARCEL E (a) SITE PLAN
L1-09	PARCEL E (b) SITE PLAN
L1-10	PARCEL E (c), O2 AND P (a) SITE PLAN
L1-11	PARCEL E (d), P (b) AND Q (a)SITE PLAN
L1-12	PARCEL Q (b) SITE PLAN
L1-13	PARCEL F SITE PLAN
L1-14 L1-15	PARCEL G SITE PLAN
L1-15 L1-16	PARCEL H/I (a) AND M3 SITE PLAN PARCEL H/I (b) SITE PLAN
L1-10 L1-17	PARCEL J (a) SITE PLAN
L1-18	PARCEL J (b) AND K SITE PLAN
L1-19	PARCEL L (a) SITE PLAN
L1-20	PARCEL L (b) AND M4 SITE PLAN
L1-21	PARCEL N SITE PLAN
L1-22	PARCEL O1 SITE PLAN
L2-01	PLANT MATRIX
L2-02	GRAND CENTRAL PARKWAY SEASONAL PLANTING DIAGRAM
1.0.04	
L3-01	IRRIGATION AND LIGHTING CONTROLS
L3-02	IRRIGATION INTENT
L3-03 L3-04	LIGHTING INTENT - PEDESTRIAN LIGHTING INTENT - PROMENADE
L3-04	LIGHTING INTENT - PROMENADE
L4-01	NOT USED
L5-01	STREET SECTIONS
L5-02	STREET SECTIONS
L5-03	STREET SECTIONS

#### **SYMBOL LEGEND**

Bollard

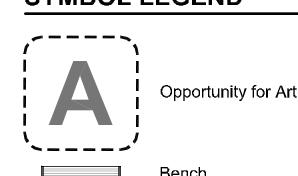



Trash Receptacle

**SITE DETAIL KEYNOTES:** 

**EXISTING CONDITIONS** 

EX.1 Utility or Other Structure

**PV** PAVEMENTS, CURBS AND RAMPS

PV.5 Stone Paver at Pedestrian Area

PV.13 Potential Driveway/Curb Cut

PV.18 Special Asphalt Paving at Vehicular Area

SITE WALLS/ EMBANKMENTS

SW.1 Cast-In-Place Concrete Seat Wall

SF.4 Movable Tables and Chairs

PV.14 12" Concrete Access Strip

PV.15 24" Concrete Buffer Strip

PV.16 Accessible Ramp A

PV.17 Accessible Ramp B

JN.1 Sawn Control Joint

JN.2 Expansion Joint

SITE FURNITURE

SF.1 Project Bench

SF.2 Not Used

SF.3 Not Used

SF.5 Not Used

SF.6 Not Used

SF.7 Trash Receptacle

SF.8 Drinking Fountain

SF.9 Bicycle Rack

SF.11 Planter Pot A

SF 12 Planter Pot B

SITE LIGHTING

SL.1 Promenade Light

PLANTING AND LANDSCAPE

PL.1 Street Tree In Landscape Panel

PL.2 Street Tree In Hardscape

PL.3 Street Tree In Tree Grate

PL.4 Palm In Landscape

PL.5 Palm In Tree Grate

PL.8 Tree Trench

BF.1 Green Screen

MS.2 Future BRT Station

MS.3 Shade Structure

SITE LAYOUT NOTES

lights and landscape panels

street or pedestrian lights

PL.6 Groundcover Planting

PL.7 Landscape Panel Planting

**BARRIERS AND FENCING** 

BF.2 Landscape Panel Barrier A

BF.3 Landscape Panel Barrier B

MISCELLANEOUS ELEMENTS

MS.1 Bus Stop - Seating Zone/Shelter

MS.4 Possible Wind Turbine Zone

MS.5 Union Park Project Signage Zone

AR.1 Art Opportunity at Shade Structure

AR.3 Art Opportunity in Pavement Design

flows in both directions form this point

Align pavement jointing with curb and gutter jointing

Orient pedestrian handicap ramps perpendicular to streetscape

Symmetrically position potential shade structures between trees

Private road. Layout to be determined after vehicular access points are identified

AR.4 Art Opportunity with Sculptural Element

AR.5 Art Opportunity with Supplemental Seating

Center point of streetscape module layout system for block face. The 2' streetscape layout module

Align pedestrian lights with street trees and street lights. Center pedestrian lights between street

Align on-street parallel parking with the streetscape layout module, e.g. street trees, pedestrian

Cut and remove existing curb. Install curb and gutter pan associated with service accesses and

parking areas. Center driveway between street trees so to lose only one tree and eliminate no

Align corner of special paving, landscape panels and tree grate with intersecting score joints

Recommend corner entrances. Consider clipping comer of building to open up plaza area at

All doors on this block face to be reassessed into architecture to insure adequate area for

Consider matching Symphony Park hardscape, pedestrian lighting and planting systems in this

**OPPORTUNITIES FOR ART** 

AR.2 Art Opportunity at Bus Stop

SF.13 Bollard

SL.2 Up Light

SF.10 Newspaper Box

PV.1 Cast In Place Concrete at Pedestrian Area

PV.4 Concrete Unit Paver at Private Vehicular Area

PV 3 Concrete Unit Paver at Pedestrian Area

PV.2 Cast In Place Concrete at Private Vehicular Area SEE CIVIL DOCUMENTS

PV.8 Potential Arch.Treatment at Public Intersection SUBJECT TO FUTURE CITY DECISION

EX.2 Traffic Signal

EX.3 Curb and Gutter

EX.4 Asphalt Paving

PV.6 Not Used

PV.7 Not Used

PV.9 Not Used

PV.10 Not Used

PV.11 Spill Curb

PV.12 Gutter Pan

PV 19 Stone Mulch

PV.20 Tree Gate A

PV.21 Tree Gate B

**JOINTING** 

LOCATION

DESIGN STANDARDS PAGE 109

DESIGN STANDARDS PAGE 110

DESIGN STANDARDS PAGE 111

SEE CIVIL DOCUMENTS

SEE RTC DOCUMENTS

ILLUSTRATED IN DETAIL PL.1

ILLUSTRATED IN DETAIL PL.1

SUBJECT TO FUTURE CITY DECISION

DESIGN STANDARDS PAGE 114

DESIGN STANDARDS PAGE 114

DESIGN STANDARDS PAGE 115

DESIGN STANDARDS PAGE 115

DESIGN STANDARDS PAGE 116

DESIGN STANDARDS PAGE 116

DESIGN STANDARDS PAGE 117

DESIGN STANDARDS PAGE 118

DESIGN STANDARDS PAGE 118

DESIGN STANDARDS PAGE 119

DESIGN STANDARDS PAGE 119

DESIGN STANDARDS PAGE 119

DESIGN STANDARDS PAGE 120

DESIGN STANDARDS PAGE 120

**DESIGN STANDARDS PAGE 121** 

DESIGN STANDARDS PAGE 121

DESIGN STANDARDS PAGE 122

DESIGN STANDARDS PAGE 123

DESIGN STANDARDS PAGE 124

**DESIGN STANDARDS PAGE 125** 

DESIGN STANDARDS PAGE 126

**DESIGN STANDARDS PAGE 127** 

DESIGN STANDARDS PL.1 PAGE 123

DESIGN STANDARDS PAGE 128

DESIGN STANDARDS PAGE 128

DESIGN STANDARDS PAGE 129

DESIGN STANDARDS PAGE 129

REFER TO AR.1 ON PAGE 130

DESIGN STANDARDS PAGE 130

DESIGN STANDARDS PAGE 130

DESIGN STANDARDS PAGE 130

DESIGN STANDARDS PAGE 131

DESIGN STANDARDS PAGE 131

DESIGN STANDARDS PAGE 131

9

N/A - WORK BY OTHERS

N/A - WORK BY OTHERS

SEE SHEET L2-01 AND L2-02

SEE SHEET L2-01

REFER TO SHEET L3-03

REFER TO SHEET L3-04

N/A

N/A



Moveable Table and Chairs



Green Screen



Drinking Fountain

Street Tree (Actual Symbol Varies Per Street)



Pedestrian Light

Centennial Street



Tree Grate

Tree Trench



Pedestrian Ramp

Point of Beginning For

Streetscape Layout

Seating Zone/Shelter

Cast-in-Place Concrete

With Sawn Control Joint

Concrete Unit Pavers


Site Line Setback


Bus Stop


Planter Pots



Potential Wind Turbine

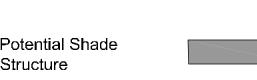

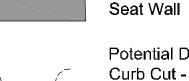

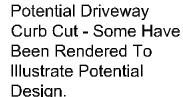

### Design

#### SL.3 Pedestrian Light SL.4 Down Light SL.5 Street Light SL.6 Street Light - Phase 2 - Proposed Location

### Planting Area - Agave

Planting Area - Acacia redolens 'desert carpet'

Planting Area -

Damianita

Planting Area -

Planting Area -

Planting Area -

'Thunder Cloud'

'∨alentine'


Chrysactinia mexicana

Eremophila maculata

Muhlenbergia capillaris

Leucophyllum candidum

(Lam.) 'Regal Mist'

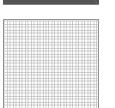

**HATCH LEGEND** 


Stone Paving Promenade Only


RUVO


Planting Area


(Grasses)



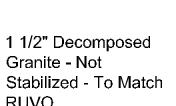

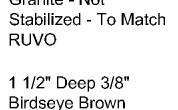

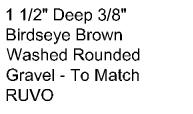

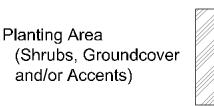















7

(13) Potential vehicular deceleration lane (14) Potential landscape panel zone - dependant on adjacent use

(10)

(15) Coordinate curb and tree layout with BRT design

pedestrian circulation

Retain 10 foot pedestrian clear zone. Refer to Design Standards for clarification

#### CITY OF LAS VEGAS

#### **NEWLAND COMMUNITIES**

#### DESIGNWORKSHOP

Landscape Architecture • Land Planning Urban Design • Tourism Planning

Asheville - Aspen - Austin - Denver Phoenix - Salt Lake City - Tahoe

224 South 200 West Suite 150 Salt Lake City, Utah 84101 (801) 359-4771 Facsimile (801) 359-4411

W W W .D E S I G N W O R K S H O P .C O M

# 

ISSUE DATE: November 9, 2007 THIS PACKAGE REPRESENTS 100% SCHEMATIC STREETSCAPE DESIGN. THIS WORK IS CO-

BASE. THIS ENGINEERING BASE IS SUBJECT TO CHANGE AND REFINEMENTS DO TO CITY REVIEW. REVISIONS # DATE DESCRIPTION 1 07/10/2007 PROMENADE CLEAR ZONE 2 09/07/2007 PRIVATE STREET LIGHTING

ORDINATED WITH AN IN-PROGRESS ENGINEERING

09/07/2007 PARCEL F/G PRIVATE ST. 11/09/2007 STREET LIGHTS 5 01/08/2008 FINAL EDITS 6 12/12/2008 SD NOTE ADDITION 7 06/05/2009 NAME REVISIONS


### SCHEMATIC DESIGN

PROJECT NUMBER: 4035

**GENERAL** INFORMATION

SHEET NUMBER

OCOPYRIGHT DESIGNWORKSHOP, IN

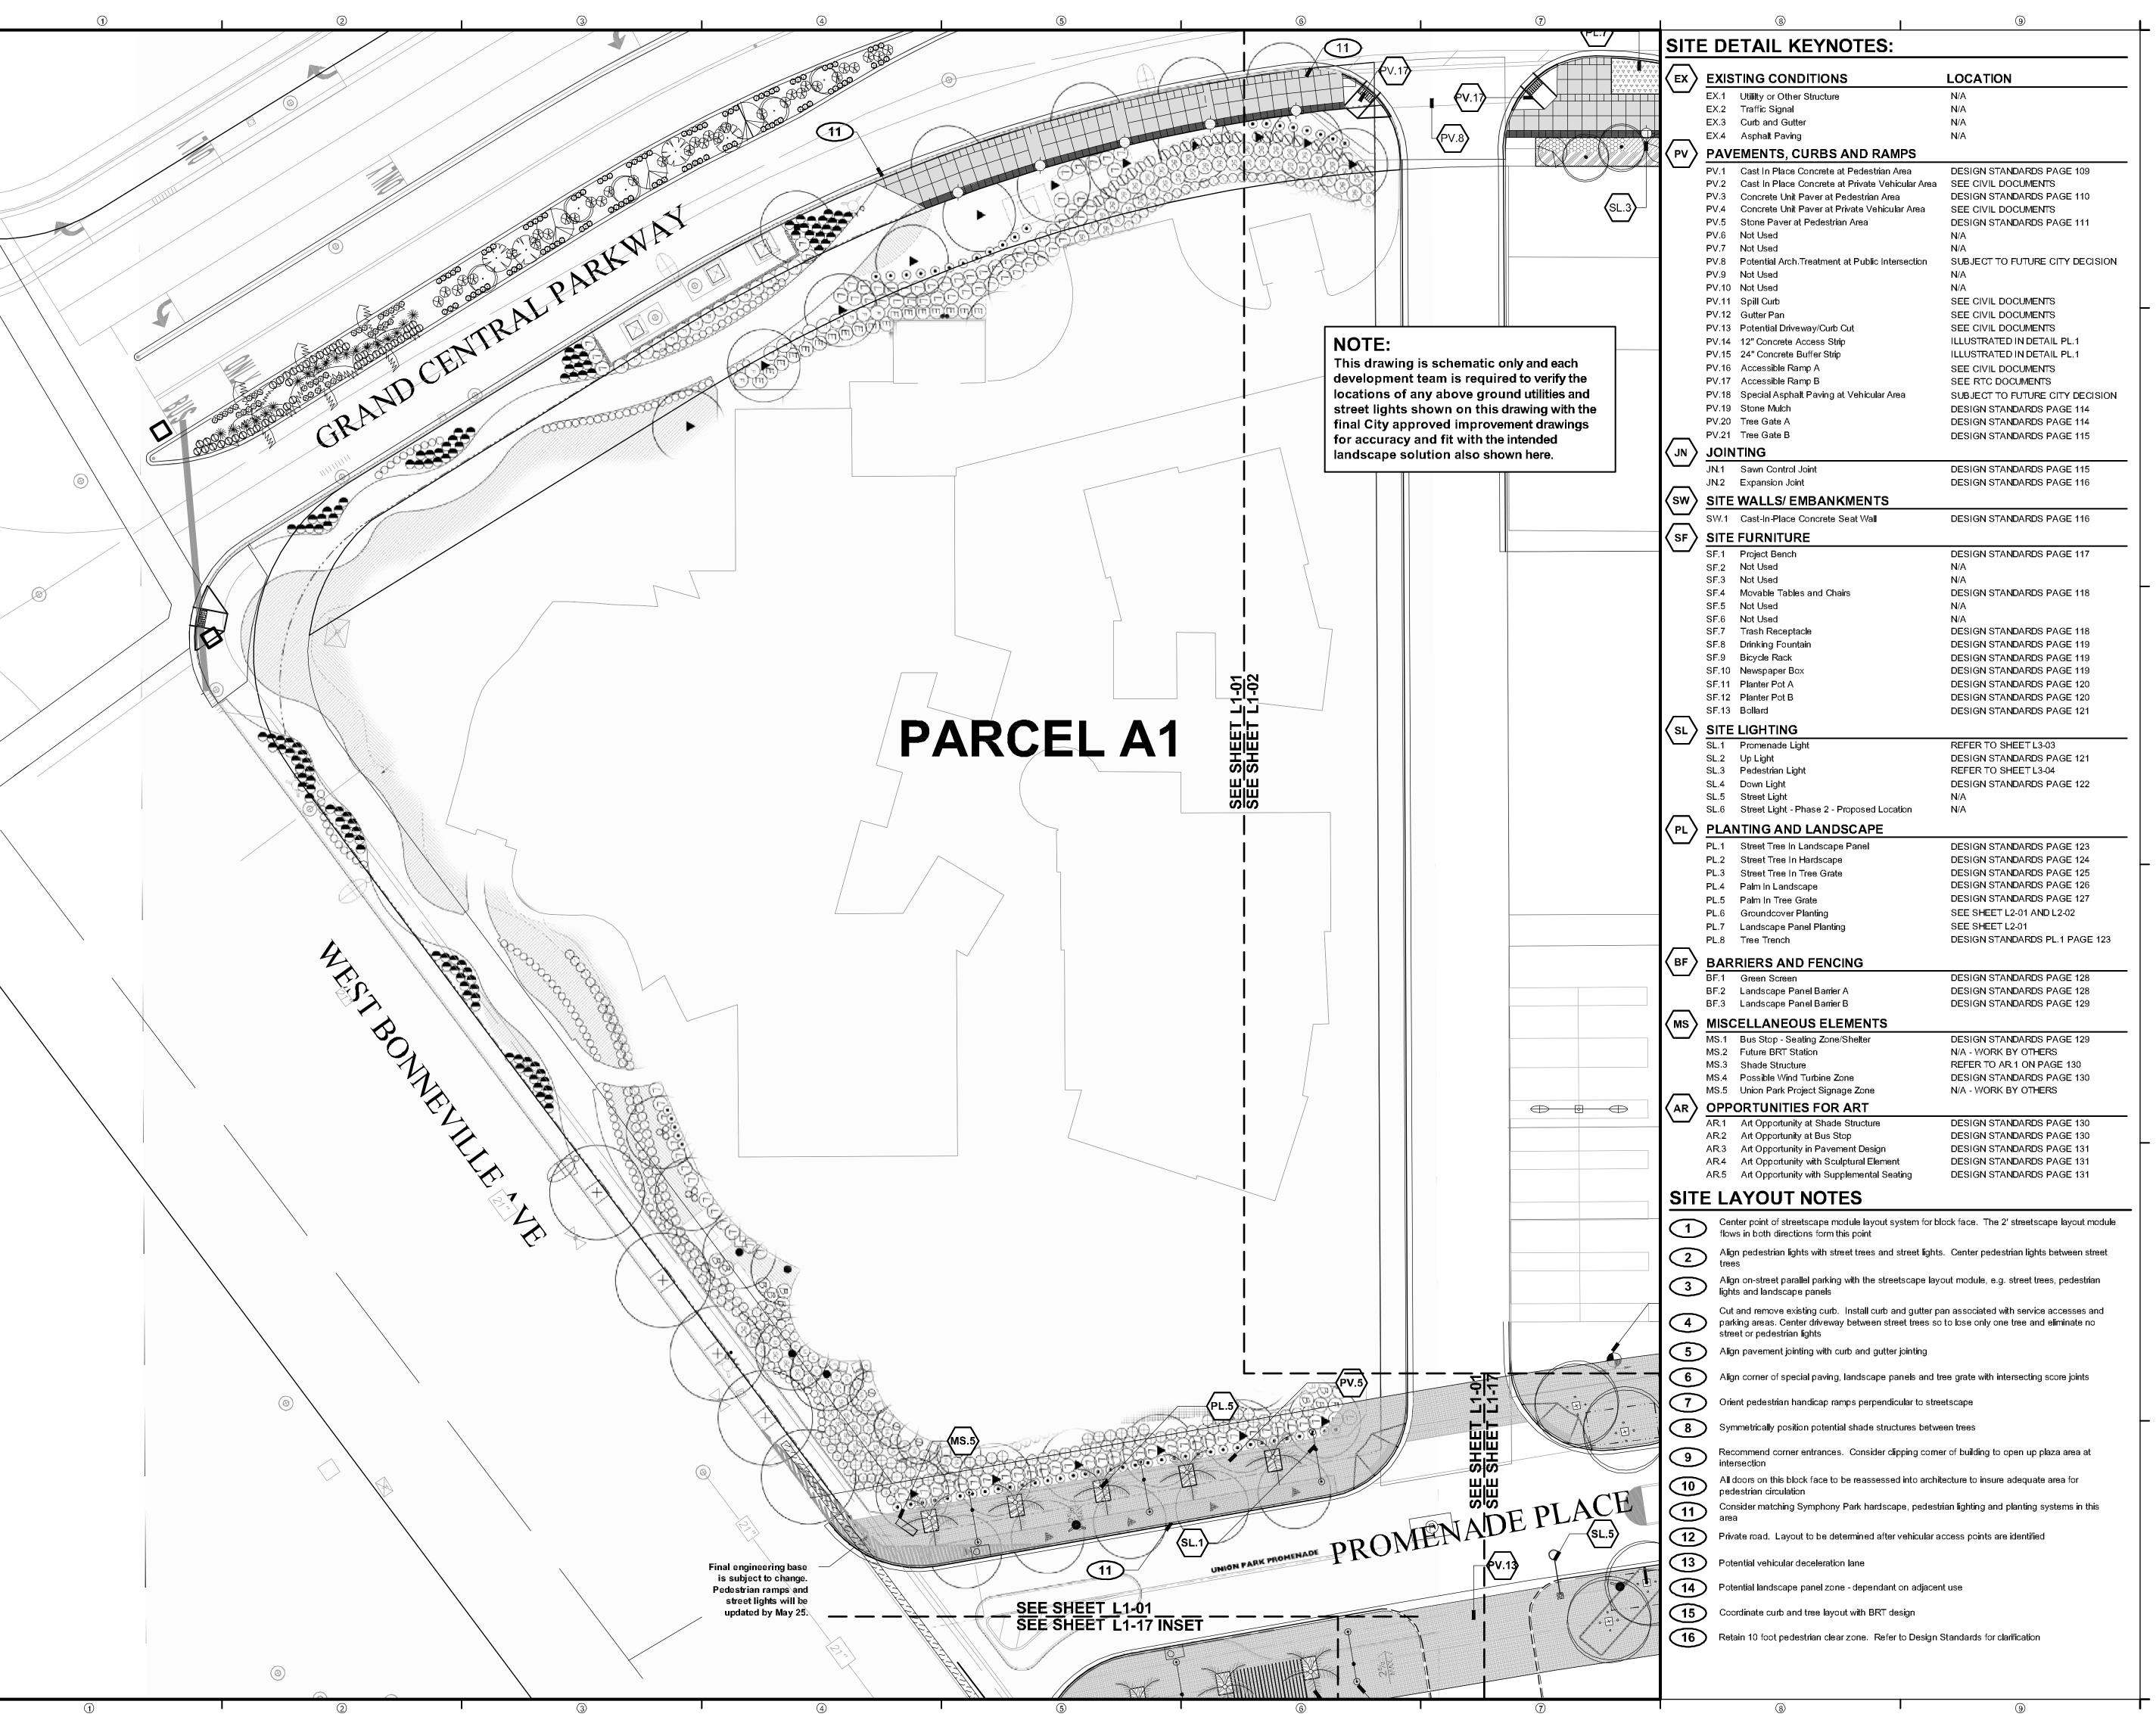

**NEWLAND COMMUNITIES** 

#### **DESIGN**WORKSHOP


Landscape Architecture • Land Planning Urban Design • Tourism Planning


Asheville - Aspen - Austin - Denver

Phoenix - Salt Lake City - Tahoe 224 South 200 West Suite 150

Salt Lake City, Utah 84101 (801) 359-4771 Facsimile (801) 359-4411

W W W.D E S I G N W O R K S H O P.C O M

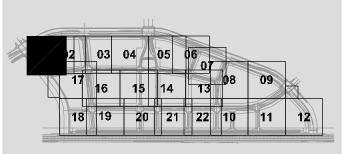

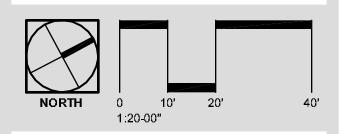

ISSUE DATE: November 9, 2007 THIS PACKAGE REPRESENTS 100% SCHEMATIC ORDINATED WITH AN IN-PROGRESS ENGINEERING BASE. THIS ENGINEERING BASE IS SUBJECT TO CHANGE AND REFINEMENTS DO TO CITY REVIEW REVISIONS

07/10/2007 PROMENADE CLEAR ZONE 09/07/2007 PRIVATE STREET LIGHTING 09/07/2007 PARCEL F/G PRIVATE ST. 11/09/2007 STREET LIGHTS 5 01/08/2008 FINAL EDITS

6 12/12/2008 SD NOTE ADDITION


# DATE DESCRIPTION

7 06/05/2009 NAME REVISIONS

#### SCHEMATIC DESIGN

PROJECT NUMBER: 4035

PARCEL A1 SITE PLAN

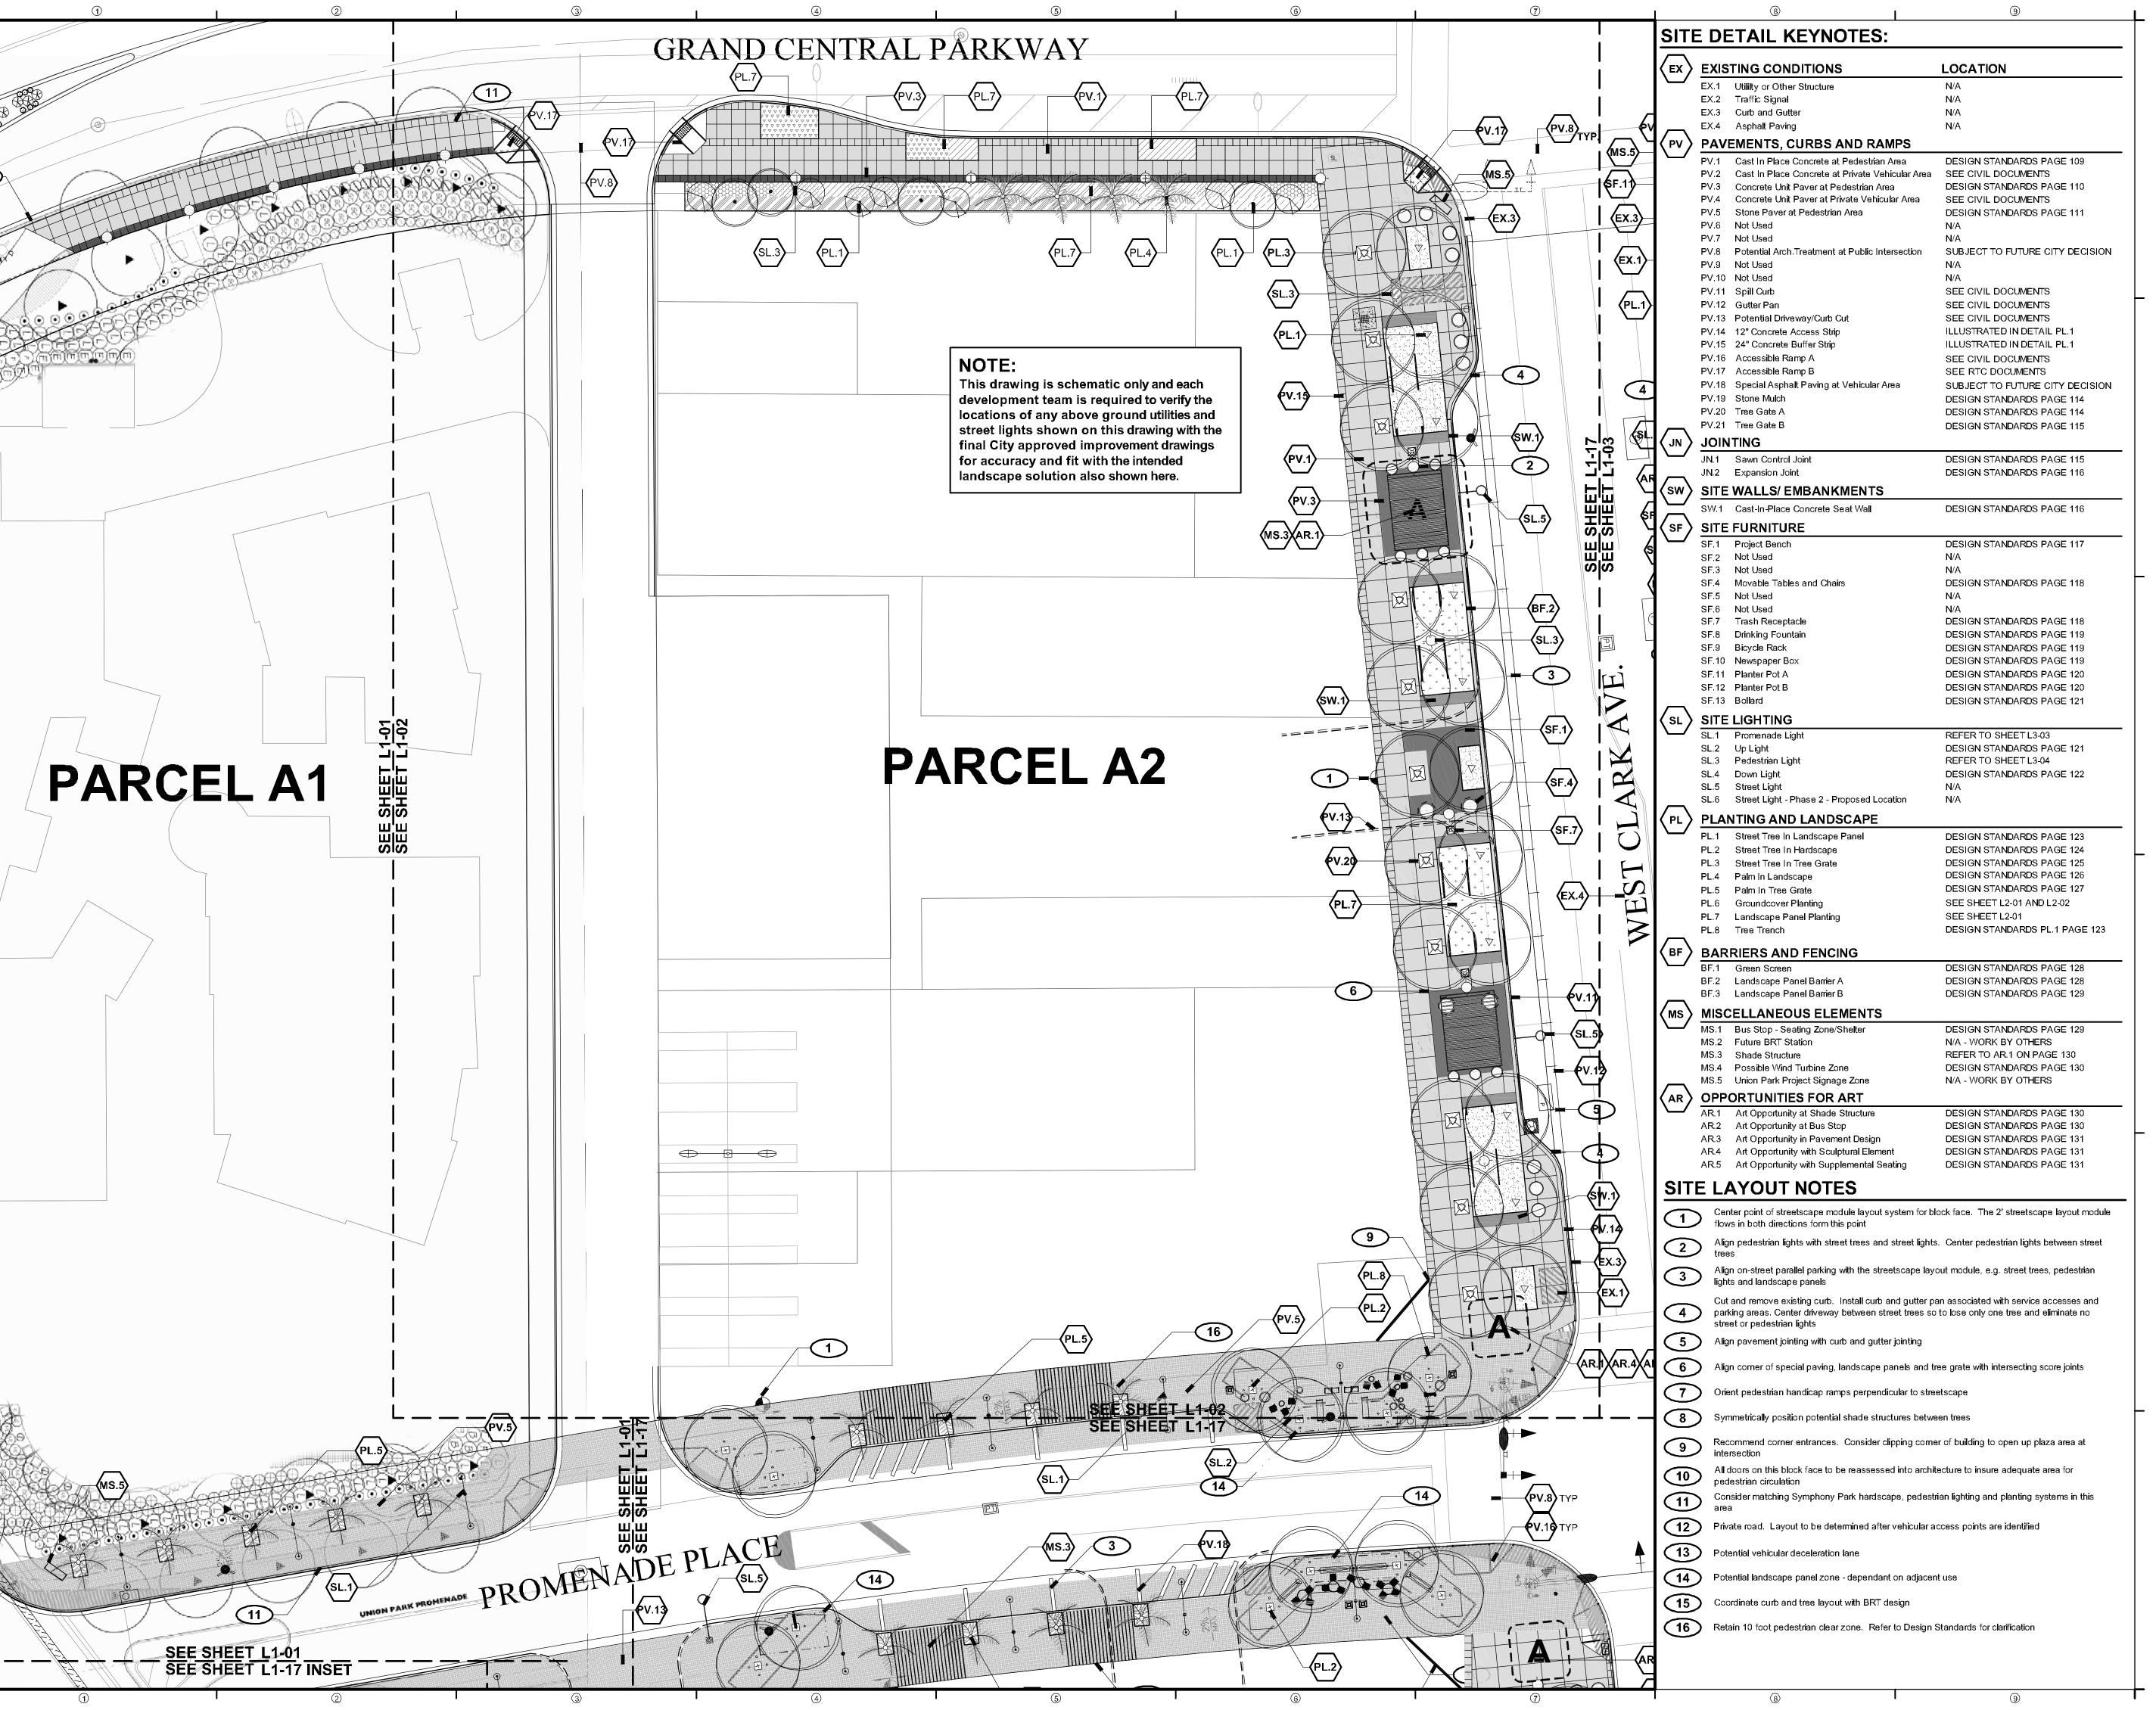

**NEWLAND COMMUNITIES** 

#### **DESIGN**WORKSHOP

Landscape Architecture • Land Planning
Urban Design • Tourism Planning

Phoenix - Salt Lake City - Tahoe


224 South 200 West Suite 150


Asheville - Aspen - Austin - Denver

224 South 200 West Suite 150 Salt Lake City, Utah 84101 (801) 359-4771 Facsimile (801) 359-4411

 $\\ \textbf{W} \ \textbf{W} \ \textbf{D} \ \textbf{E} \ \textbf{S} \ \textbf{I} \ \textbf{G} \ \textbf{N} \ \textbf{W} \ \textbf{O} \ \textbf{R} \ \textbf{K} \ \textbf{S} \ \textbf{H} \ \textbf{O} \ \textbf{P} . \ \textbf{C} \ \textbf{O} \ \textbf{M}$ 

PHONY PARK SCAPE SCHEMATIC DESIGN

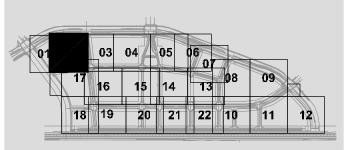

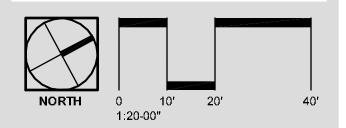

ISSUE DATE: November 9, 2007

THIS PACKAGE REPRESENTS 100% SCHEMATIC STREETSCAPE DESIGN. THIS WORK IS CO-ORDINATED WITH AN IN-PROGRESS ENGINEERING BASE. THIS ENGINEERING BASE IS SUBJECT TO CHANGE AND REFINEMENTS DO TO CITY REVIEW. REVISIONS

 1
 07/10/2007
 PROMENADE CLEAR ZONE

 2
 09/07/2007
 PRIVATE STREET LIGHTING

 3
 09/07/2007
 PARCEL F/G PRIVATE ST.

 4
 11/09/2007
 STREET LIGHTS

 5
 01/08/2008
 FINAL EDITS


# DATE DESCRIPTION

5 01/08/2008 FINAL EDITS
6 12/12/2008 SD NOTE ADDITION
7 06/05/2009 NAME REVISIONS

### SCHEMATIC DESIGN

PROJECT NUMBER: 4035

PARCEL A2 SITE PLAN

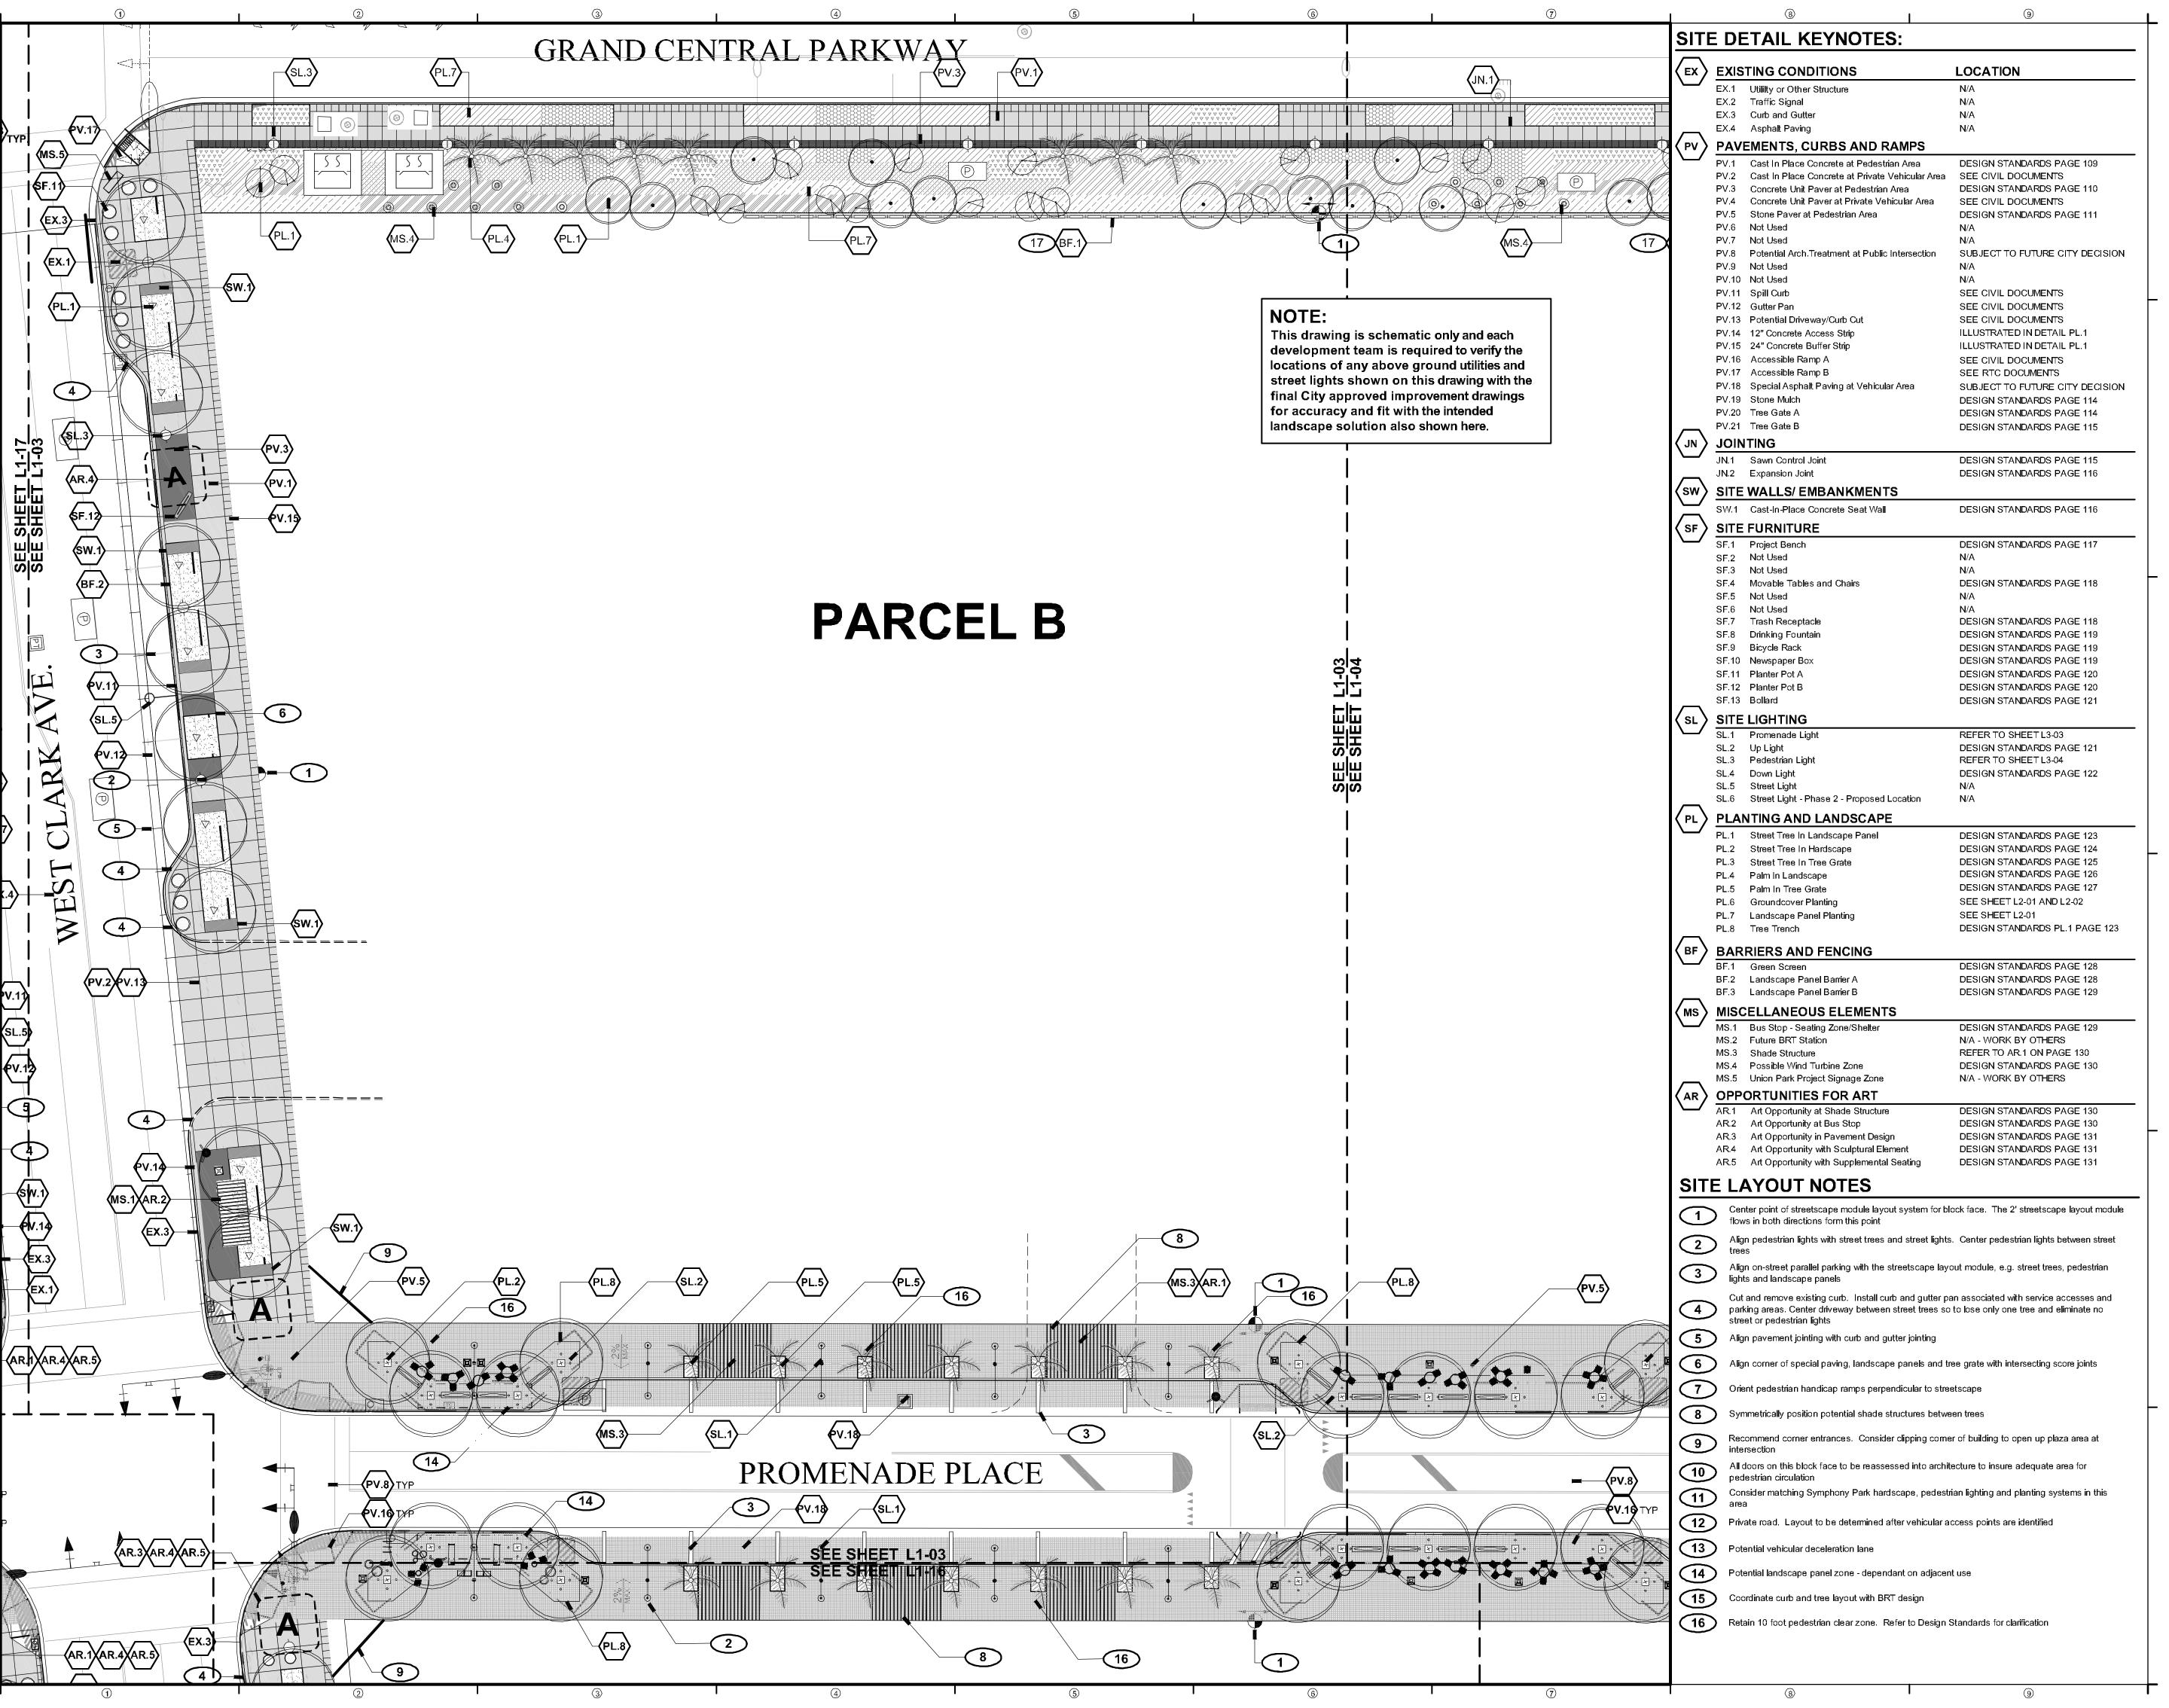

**NEWLAND COMMUNITIES** 

#### **DESIGN**WORKSHOP

Landscape Architecture • Land Planning Urban Design • Tourism Planning


Asheville - Aspen - Austin - Denver Phoenix - Salt Lake City - Tahoe 224 South 200 West Suite 150


Salt Lake City, Utah 84101 (801) 359-4771 Facsimile (801) 359-4411

W W W.D E S I G N W O R K S H O P.C O M

R K ESIGN

YMPHONY PAR TREETSCAPE SCHEMATIC DESIG

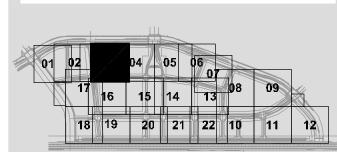

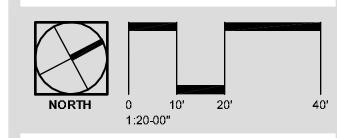

ISSUE DATE: November 9, 2007

THIS PACKAGE REPRESENTS 100% SCHEMATIC STREETSCAPE DESIGN. THIS WORK IS CO-ORDINATED WITH AN IN-PROGRESS ENGINEERING BASE. THIS ENGINEERING BASE IS SUBJECT TO CHANGE AND REFINEMENTS DO TO CITY REVIEW. REVISIONS

 1
 07/10/2007
 PROMENADE CLEAR ZONE

 2
 09/07/2007
 PRIVATE STREET LIGHTING

 3
 09/07/2007
 PARCEL F/G PRIVATE ST.

 4
 11/09/2007
 STREET LIGHTS

 5
 01/08/2008
 FINAL EDITS

# DATE DESCRIPTION

6 12/12/2008 SD NOTE ADDITION
7 06/05/2009 NAME REVISIONS


### SCHEMATIC DESIGN

PROJECT NUMBER: 4035

PARCEL B (a) SITE PLAN

SHEET NUMBER

OCOPYRIGHT DESIGNWORKSHOP, IN

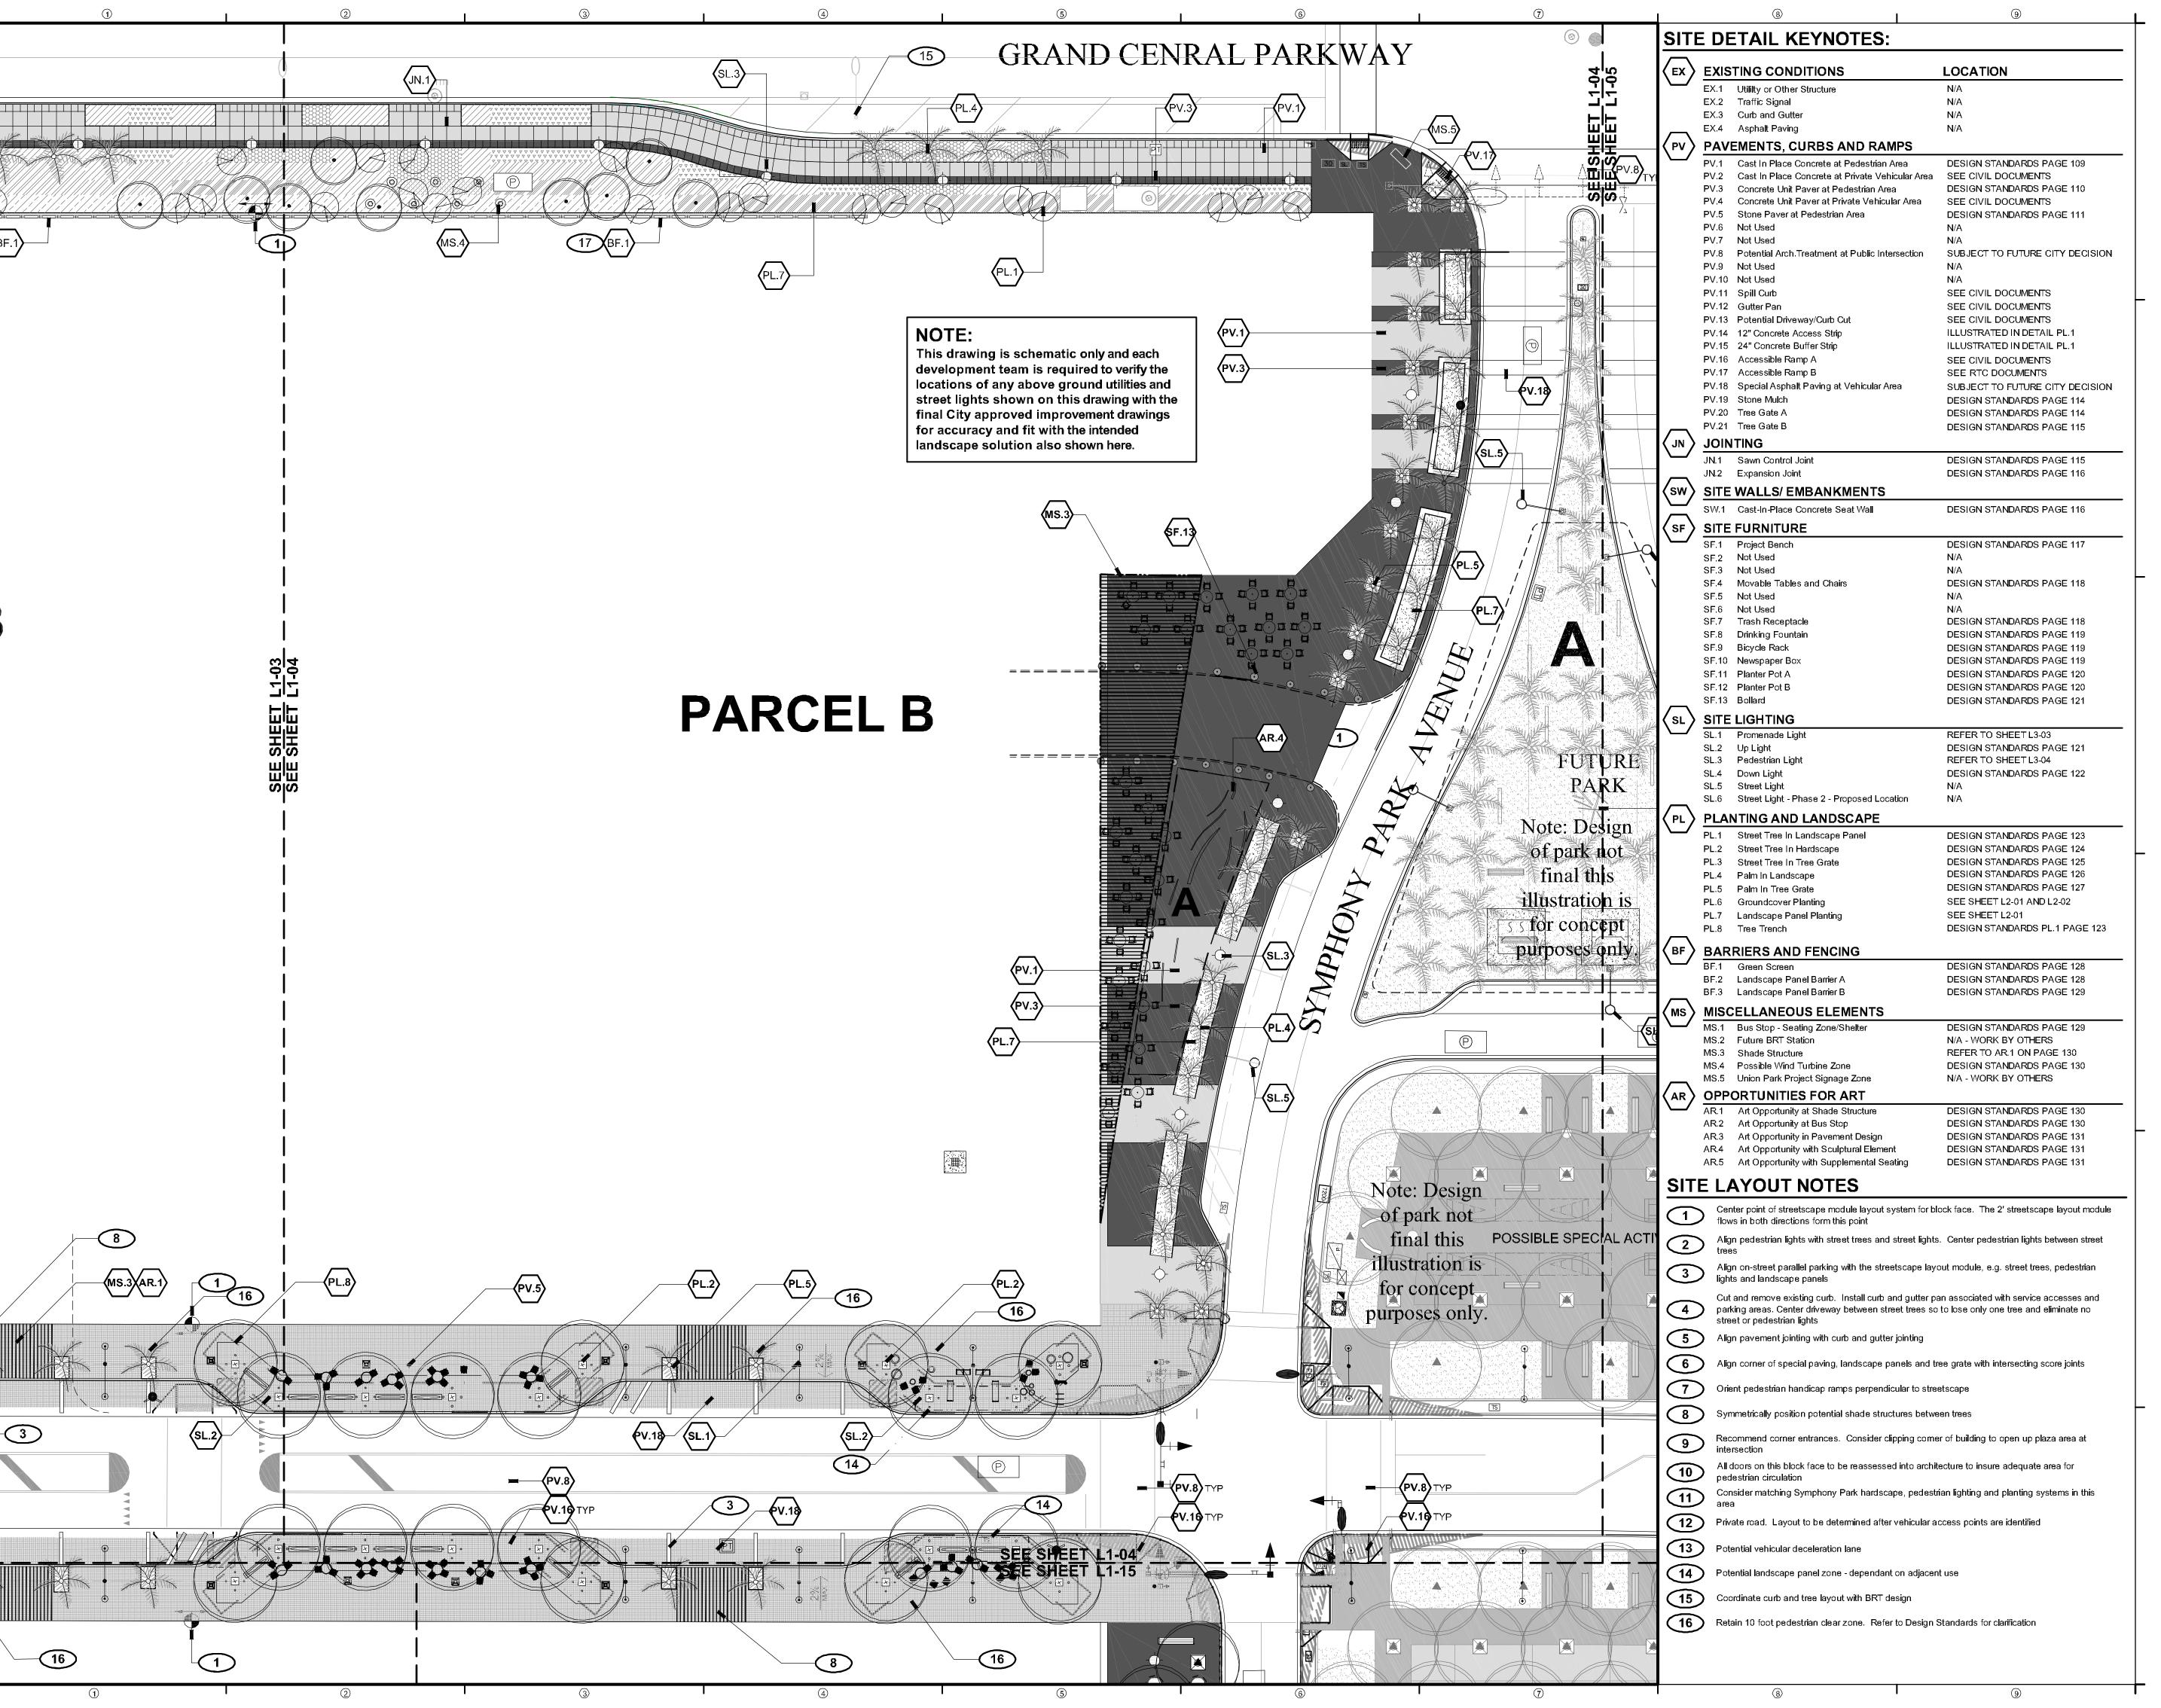

**NEWLAND COMMUNITIES** 

#### **DESIGN**WORKSHOP

Landscape Architecture • Land Planning
Urban Design • Tourism Planning

-Asheville - Aspen - Austin - Denver Phoenix - Salt Lake City - Tahoe


224 South 200 West Suite 150 Salt Lake City, Utah 84101 (801) 359-4771


W W W .D E S I G N W O R K S H O P .C O M

Facsimile (801) 359-4411

Z Z

STREETSCAPE SCHEMATIC DESIG

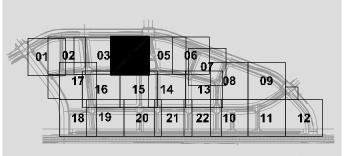

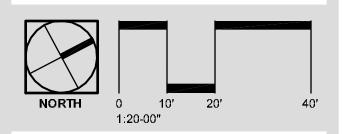

ISSUE DATE: November 9, 2007

THIS PACKAGE REPRESENTS 100% SCHEMATIC STREETSCAPE DESIGN. THIS WORK IS CO-ORDINATED WITH AN IN-PROGRESS ENGINEERING BASE. THIS ENGINEERING BASE IS SUBJECT TO CHANGE AND REFINEMENTS DO TO CITY REVIEW. REVISIONS

# DATE DESCRIPTION

1 07/10/2007 PROMENADE CLEAR ZONE

2 09/07/2007 PRIVATE STREET LIGHTING

3 09/07/2007 PARCEL F/G PRIVATE ST.

4 11/09/2007 STREET LIGHTS

5 01/08/2008 FINAL EDITS

6 12/12/2008 SD NOTE ADDITION
7 06/05/2009 NAME REVISIONS


### SCHEMATIC DESIGN

PROJECT NUMBER: 4035

PARCEL B (b), M1 AND M2 SITE PLAN

SHEET NUMBER

O COPYRIGHT DESIGNWORKSHOP, IN

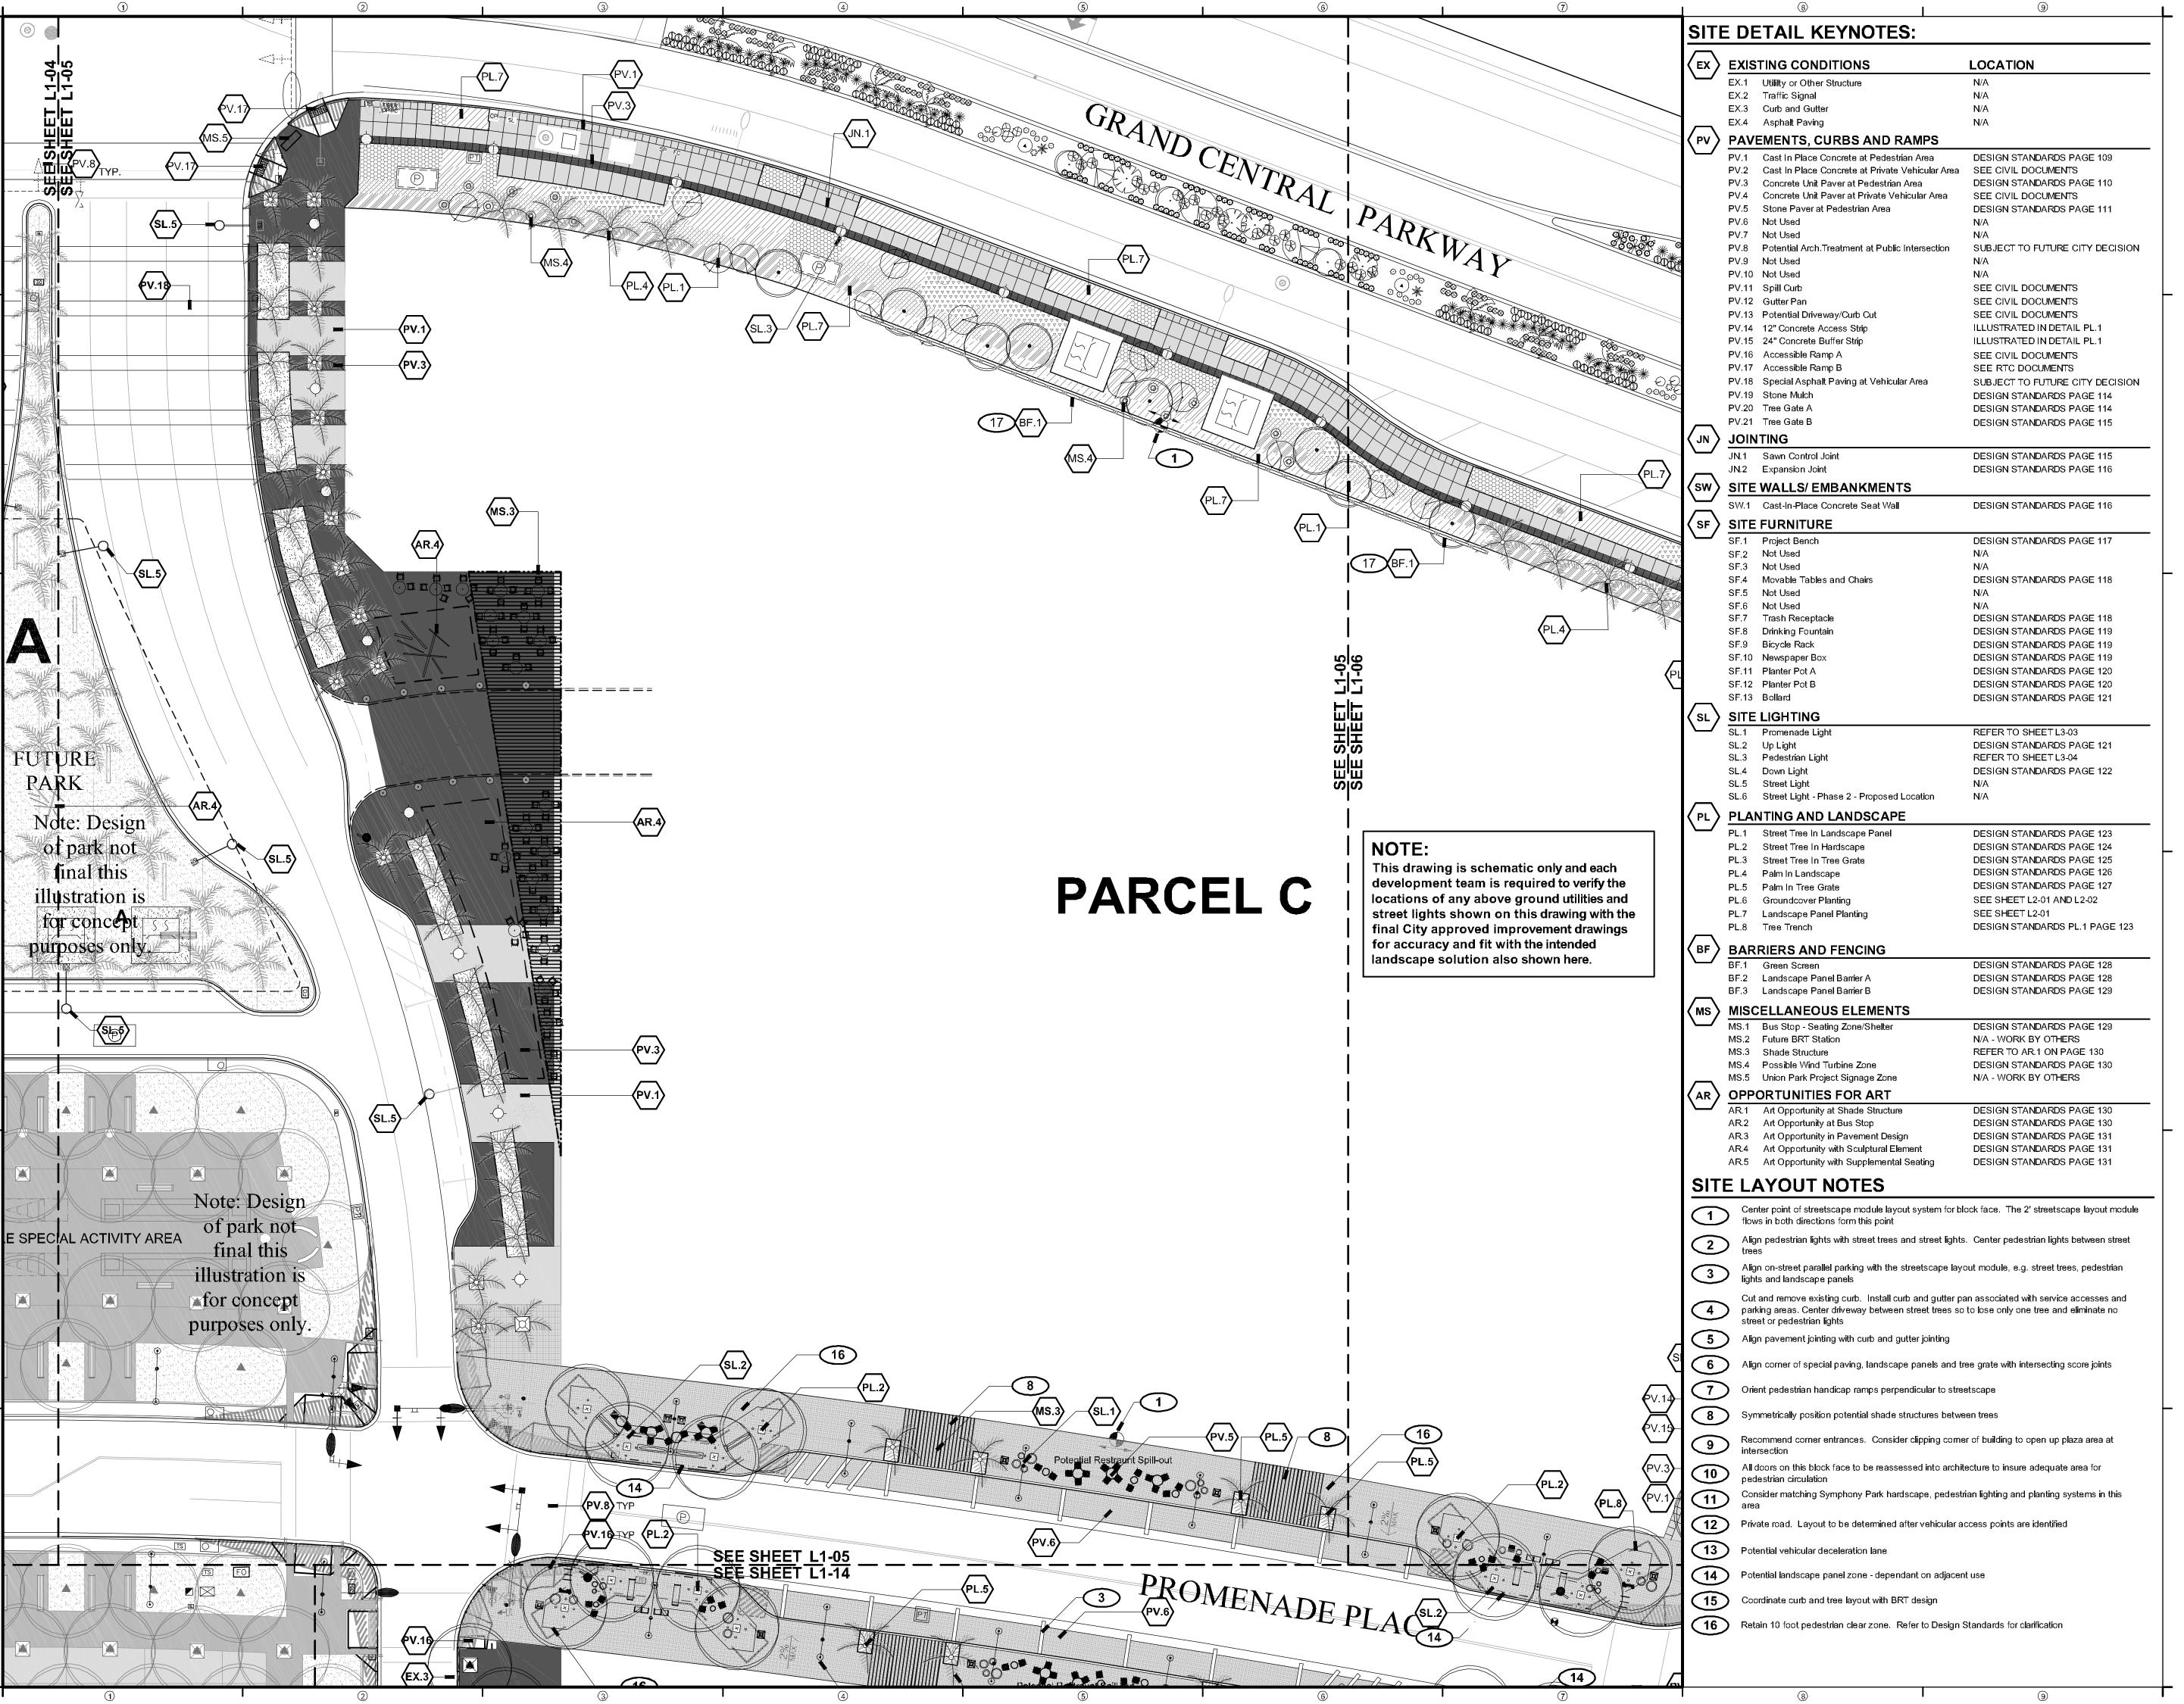

**NEWLAND COMMUNITIES** 

#### DESIGNWORKSHOP

Landscape Architecture • Land Planning
Urban Design • Tourism Planning

Asheville - Aspen - Austin - Denver Phoenix - Salt Lake City - Tahoe


224 South 200 West Suite 150 Salt Lake City, Utah 84101 (801) 359-4771


Facsimile (801) 359-4411

W W W .D E S I G N W O R K S H O P . C O M

Z X X

STREETSCAPE SCHEMATIC DESIGNATION

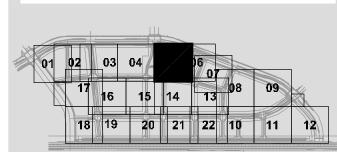

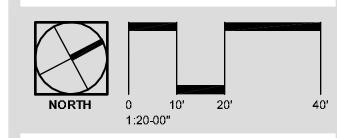

ISSUE DATE: November 9, 2007

THIS PACKAGE REPRESENTS 100% SCHEMATIC STREETSCAPE DESIGN. THIS WORK IS CO-ORDINATED WITH AN IN-PROGRESS ENGINEERING BASE. THIS ENGINEERING BASE IS SUBJECT TO CHANGE AND REFINEMENTS DO TO CITY REVIEW. REVISIONS

 1
 07/10/2007
 PROMENADE CLEAR ZONE

 2
 09/07/2007
 PRIVATE STREET LIGHTING

 3
 09/07/2007
 PARCEL F/G PRIVATE ST.

 4
 11/09/2007
 STREET LIGHTS

 5
 01/08/2008
 FINAL EDITS

5 01/08/2008 FINAL EDITS
6 12/12/2008 SD NOTE ADDITION
7 06/05/2009 NAME REVISIONS

# DATE DESCRIPTION

SCHEMATIC DESIGN


PROJECT NUMBER: 4035

PARCEL M1, M2 AND C (a) SITE PLAN

SHEET NUMBER

L1-05

OCOPYRIGHT DESIGNWORKSHOP, I

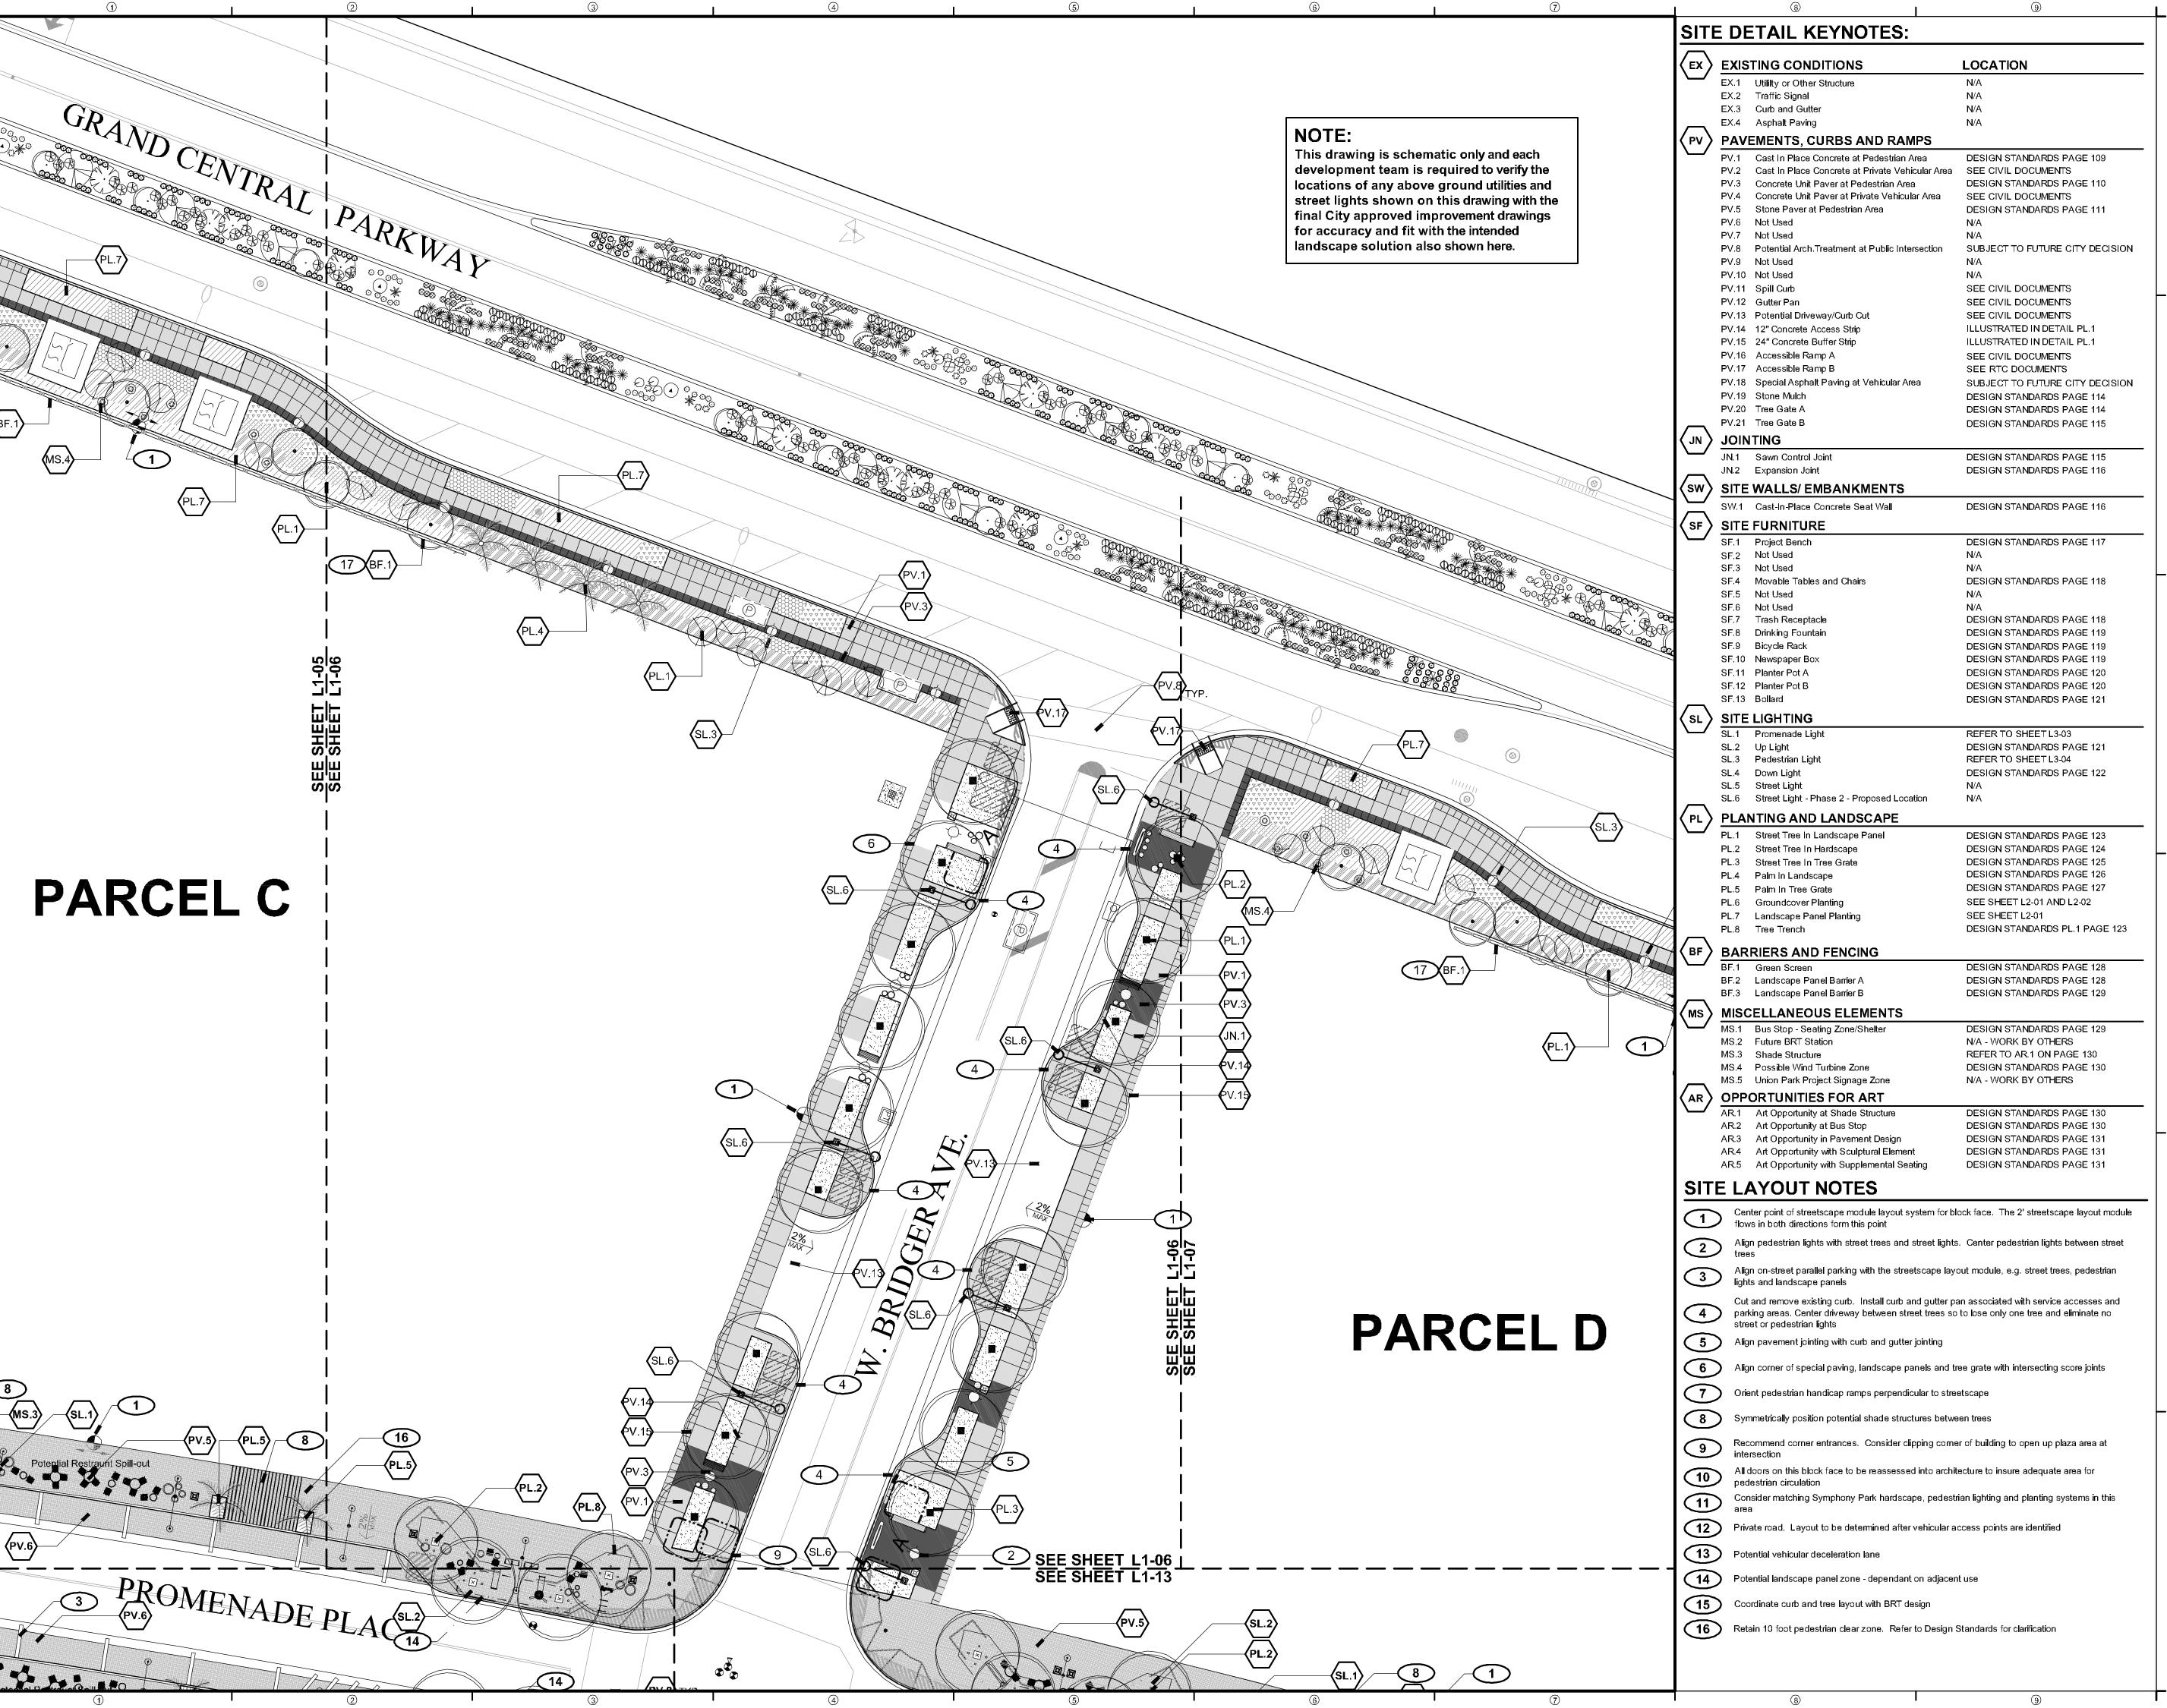

**NEWLAND COMMUNITIES** 

#### **DESIGN**WORKSHOP

Landscape Architecture • Land Planning
Urban Design • Tourism Planning

Asheville - Aspen - Austin - Denver Phoenix - Salt Lake City - Tahoe


224 South 200 West Suite 150


Salt Lake City, Utah 84101 (801) 359-4771 Facsimile (801) 359-4411

W W W.D E S I G N W O R K S H O P.C O M

A R K

YMPHONY PAR
TREETSCAPE SCHEMATIC DESIG

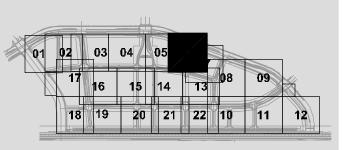

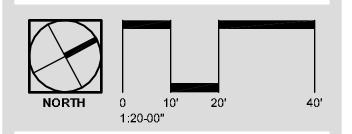

ISSUE DATE: November 9, 2007

THIS PACKAGE REPRESENTS 100% SCHEMATIC
STREETSCAPE DESIGN. THIS WORK IS COORDINATED WITH AN IN-PROGRESS ENGINEERING
BASE. THIS ENGINEERING BASE IS SUBJECT TO
CHANGE AND REFINEMENTS DO TO CITY REVIEW.
REVISIONS

#	DATE	DESCRIPTION
1	07/10/2007	PROMENADE CLEAR ZON
2	09/07/2007	PRIVATE STREET LIGHTIN
3	09/07/2007	PARCEL F/G PRIVATE ST.
4	11/09/2007	STREET LIGHTS
 5	01/08/2008	FINAL EDITS

 6
 12/12/2008
 SD NOTE ADDITION

 7
 06/05/2009
 NAME REVISIONS


### SCHEMATIC DESIGN

PROJECT NUMBER: 4035

PARCEL C (b) SITE PLAN

L1-06

O COPYRIGHT DESIGNWORKSHOP, IN

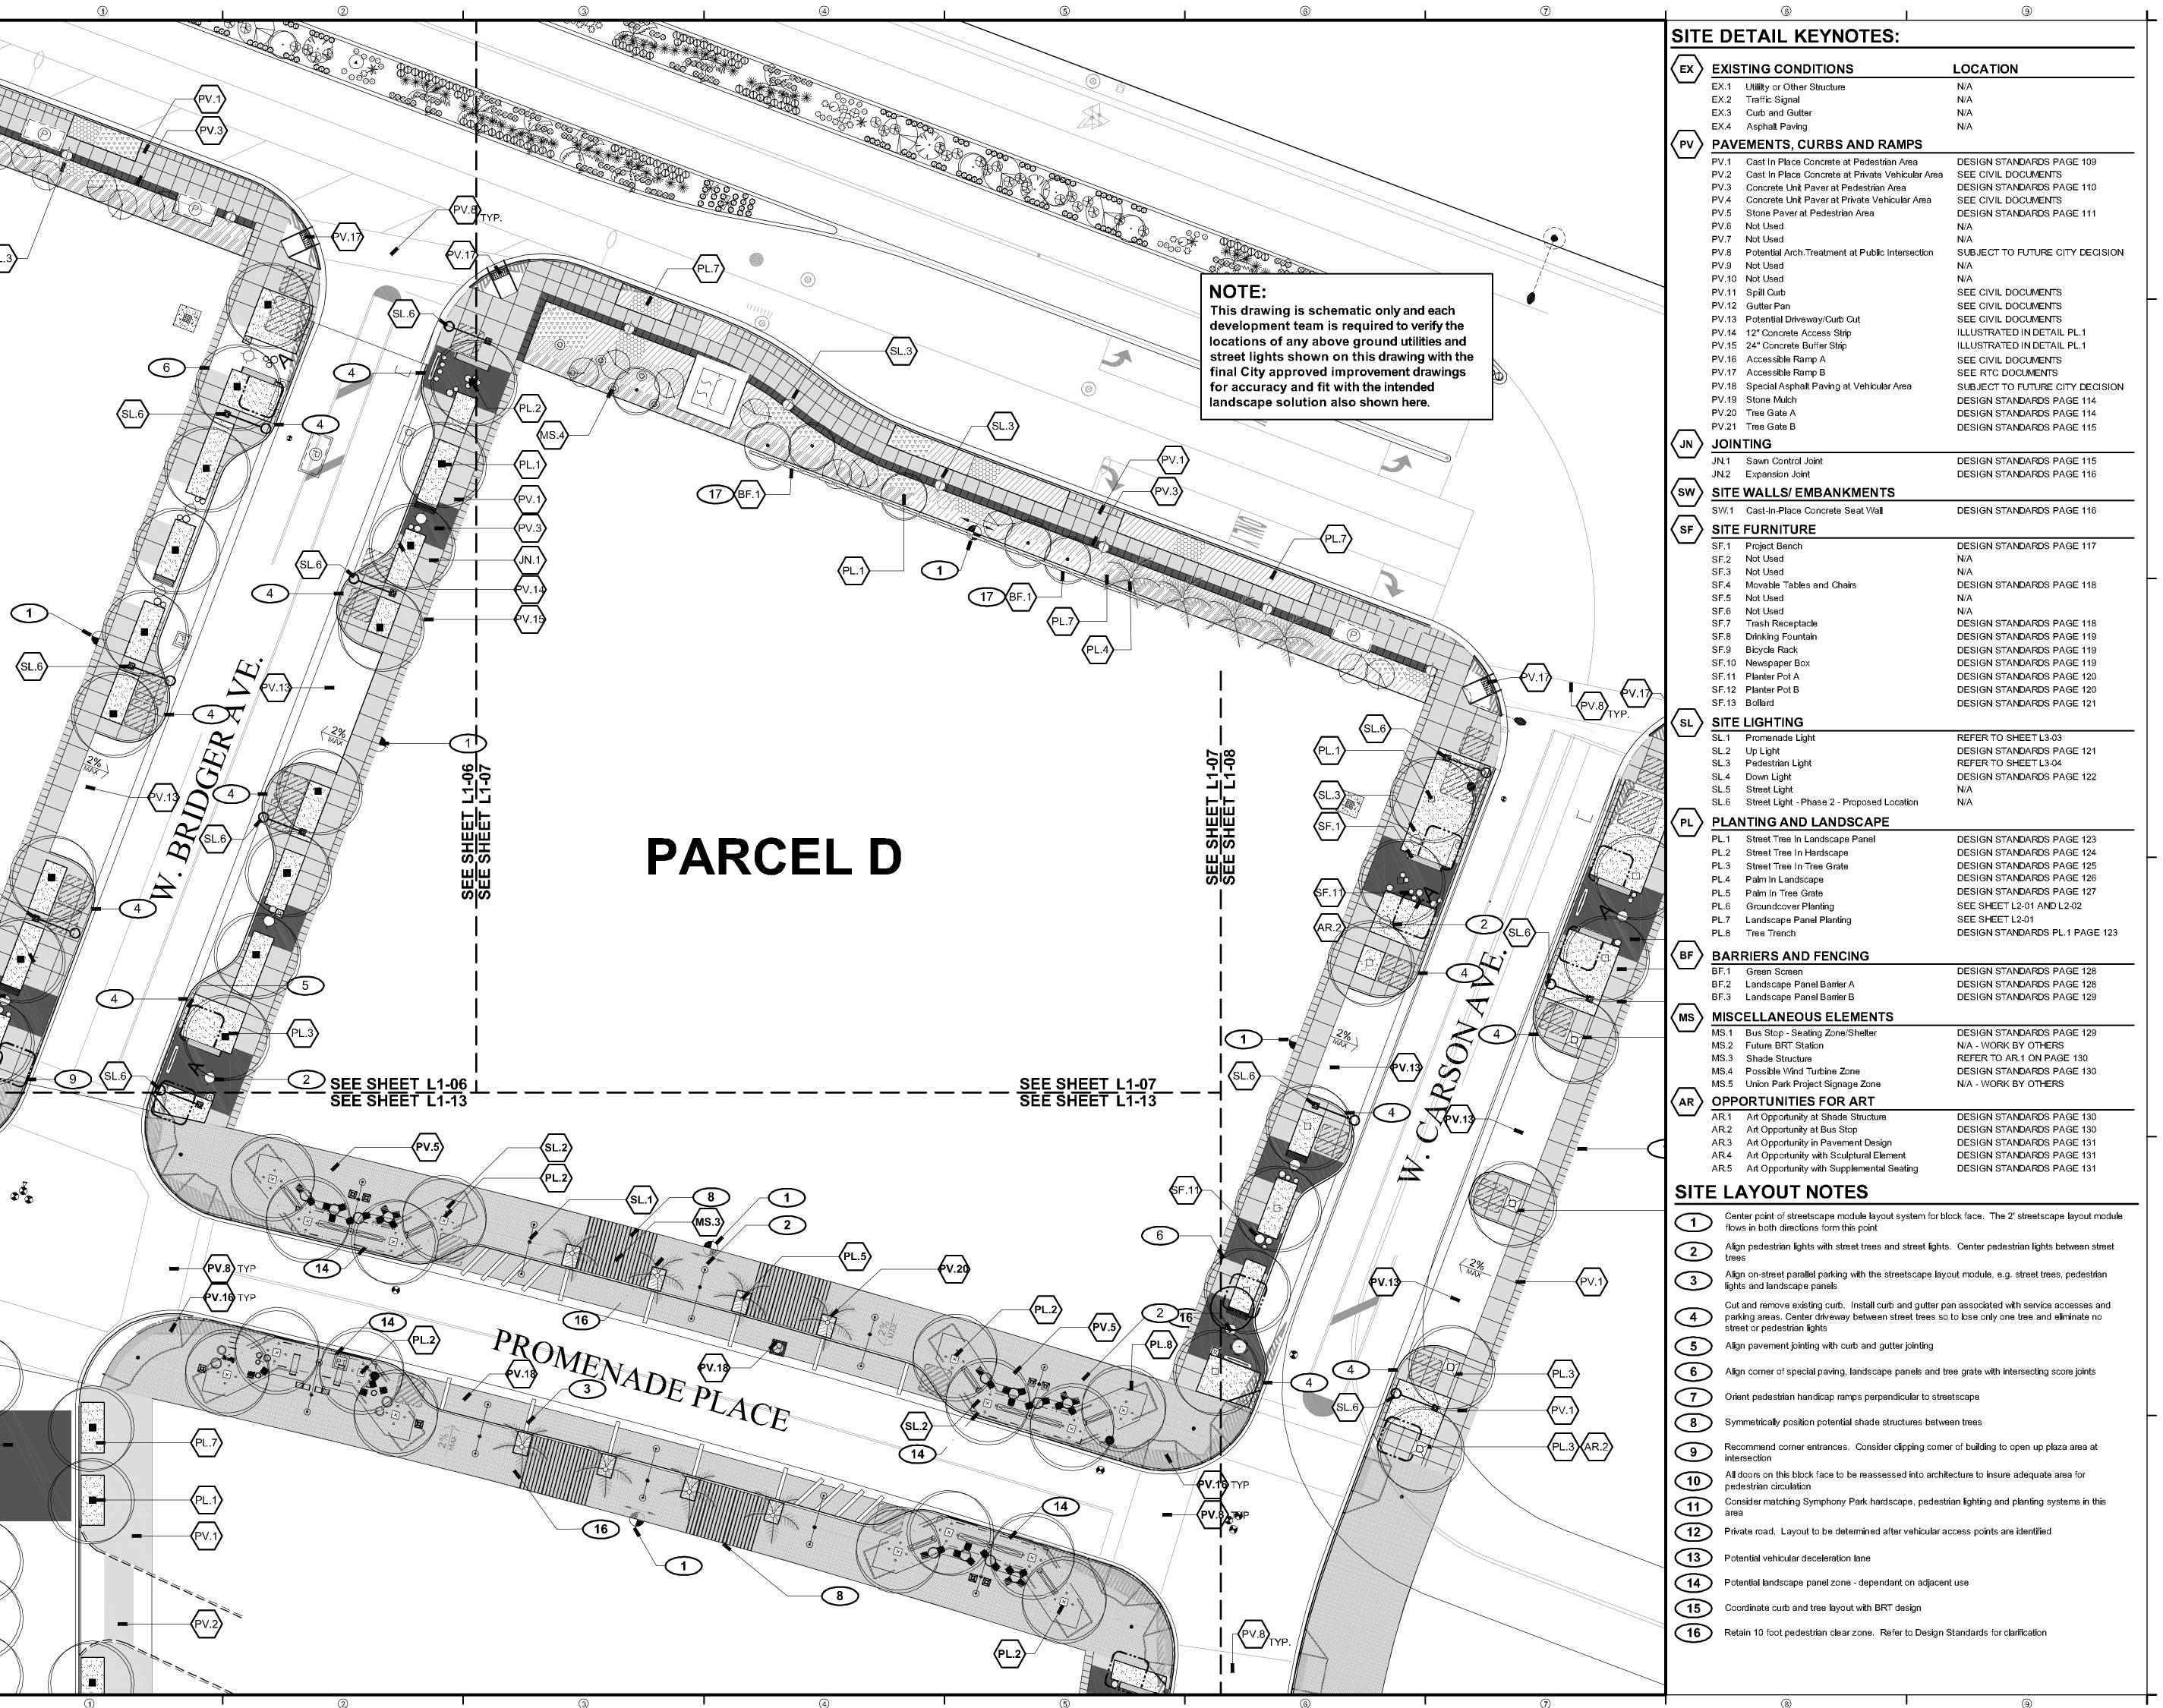

**NEWLAND COMMUNITIES** 

#### **DESIGN**WORKSHOP

Landscape Architecture • Land Planning
Urban Design • Tourism Planning

Asheville - Aspen - Austin - Denver Phoenix - Salt Lake City - Tahoe


224 South 200 West Suite 150 Salt Lake City, Utah 84101 (801) 359-4771 Facsimile (801) 359-4411


W W W.D E S I G N W O R K S H O P.C O M

א א א א

MPHONY PARK

EETSCAPE SCHEMATIC DESIGN

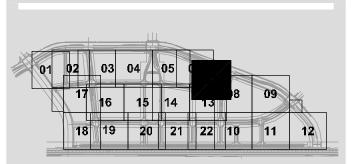

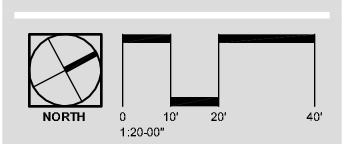

ISSUE DATE: November 9, 2007

THIS PACKAGE REPRESENTS 100% SCHEMATIC STREETSCAPE DESIGN. THIS WORK IS CO-ORDINATED WITH AN IN-PROGRESS ENGINEERING BASE. THIS ENGINEERING BASE IS SUBJECT TO CHANGE AND REFINEMENTS DO TO CITY REVIEW. REVISIONS

#	DATE	DESCRIPTION
1	07/10/2007	PROMENADE CLEAR ZON
2	09/07/2007	PRIVATE STREET LIGHTIN
3	09/07/2007	PARCEL F/G PRIVATE ST.
4	11/09/2007	STREET LIGHTS
 5	01/08/2008	FINAL EDITS

6 12/12/2008 SD NOTE ADDITION
7 06/05/2009 NAME REVISIONS


### SCHEMATIC DESIGN

PROJECT NUMBER: 4035

PARCEL D SITE PLAN

SHEET NUMBER

OCOPYRIGHT DESIGNWORKSHOP, INC.

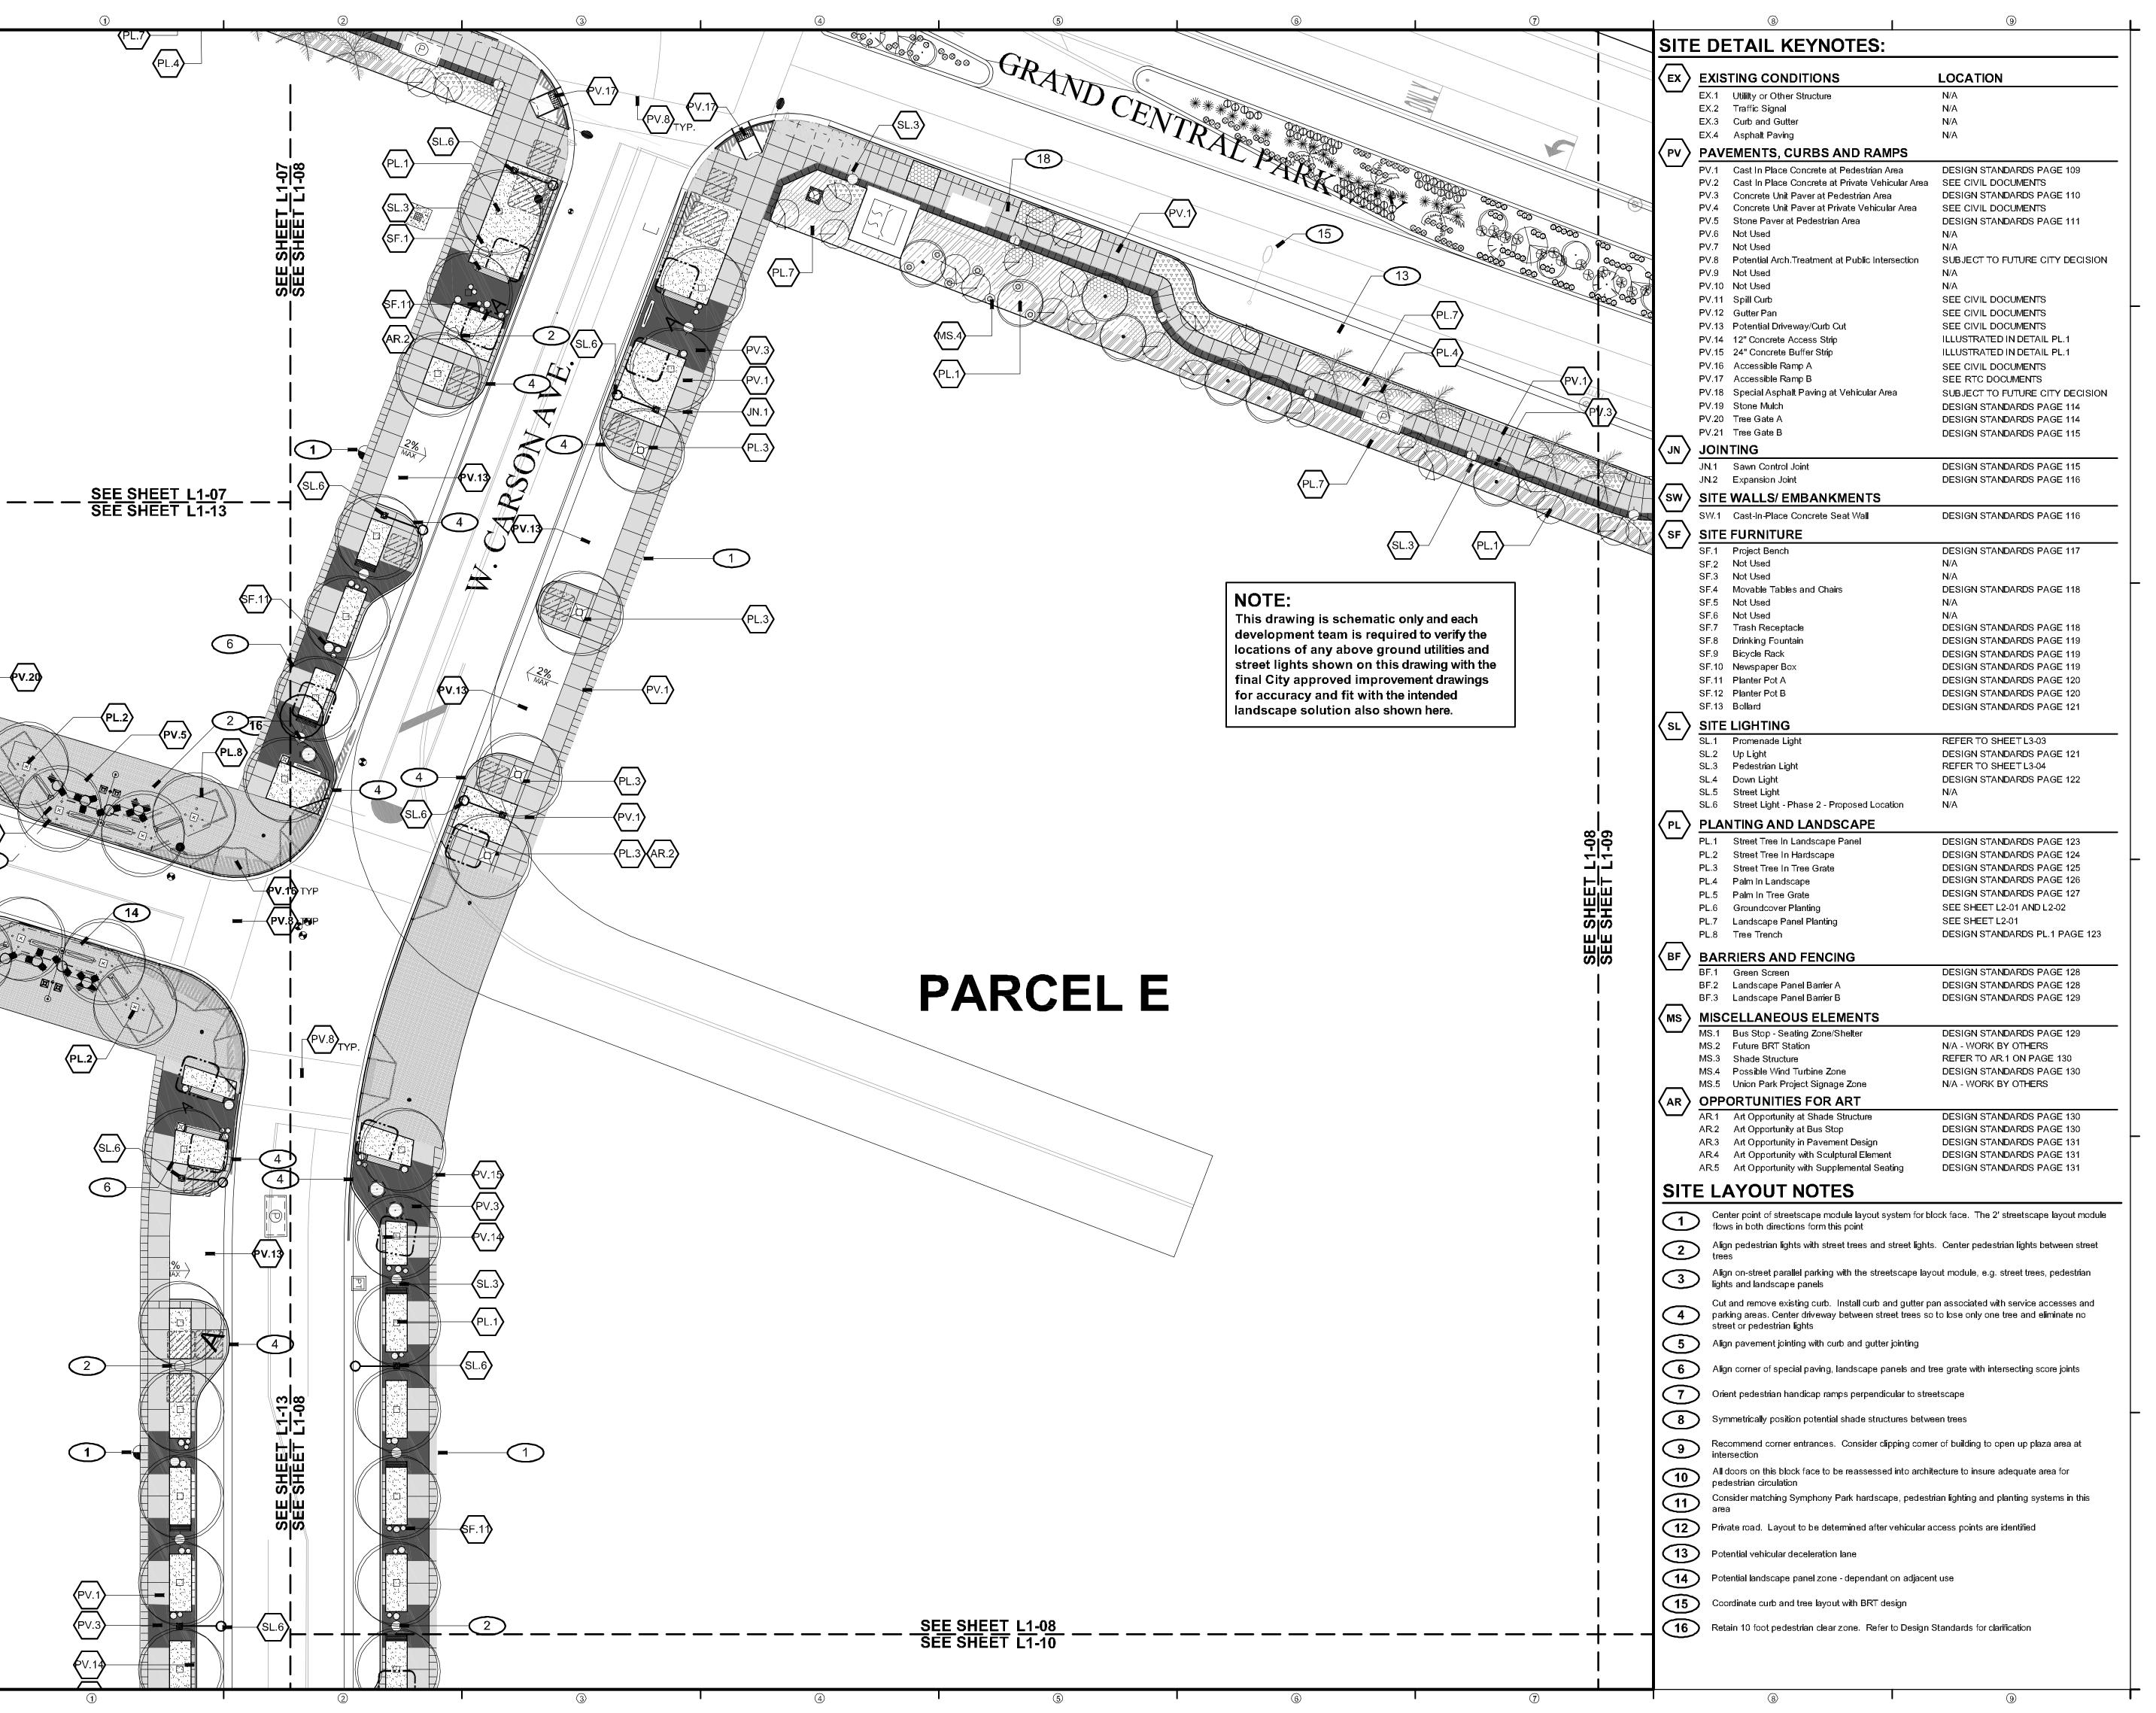

**NEWLAND COMMUNITIES** 

#### DESIGNWORKSHOP

Landscape Architecture • Land Planning
Urban Design • Tourism Planning


Asheville - Aspen - Austin - Denver Phoenix - Salt Lake City - Tahoe


224 South 200 West Suite 150 Salt Lake City, Utah 84101 (801) 359-4771 Facsimile (801) 359-4411

W W W.D E S I G N W O R K S H O P.C O M

ARK

YMPHONY PAF

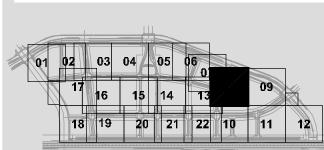

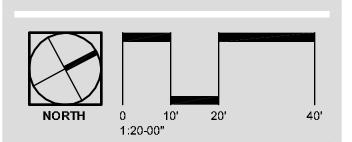

ISSUE DATE: November 9, 2007

THIS PACKAGE REPRESENTS 100% SCHEMATIC STREETSCAPE DESIGN. THIS WORK IS CO-ORDINATED WITH AN IN-PROGRESS ENGINEERING BASE. THIS ENGINEERING BASE IS SUBJECT TO CHANGE AND REFINEMENTS DO TO CITY REVIEW. REVISIONS

# DATE DESCRIPTION

1 07/10/2007 PROMENADE CLEAR ZONE

2 09/07/2007 PRIVATE STREET LIGHTING

3 09/07/2007 PARCEL F/G PRIVATE ST.

4 11/09/2007 STREET LIGHTS

 5
 01/08/2008
 FINAL EDITS

 6
 12/12/2008
 SD NOTE ADDITION

 7
 06/05/2009
 NAME REVISIONS

SCHEMATIC


### SCHEMATIC DESIGN

PROJECT NUMBER: 4035

PARCEL E (a) SITE PLAN

L1-08

OCOPYRIGHT DESIGNWORKSHOP, INC.

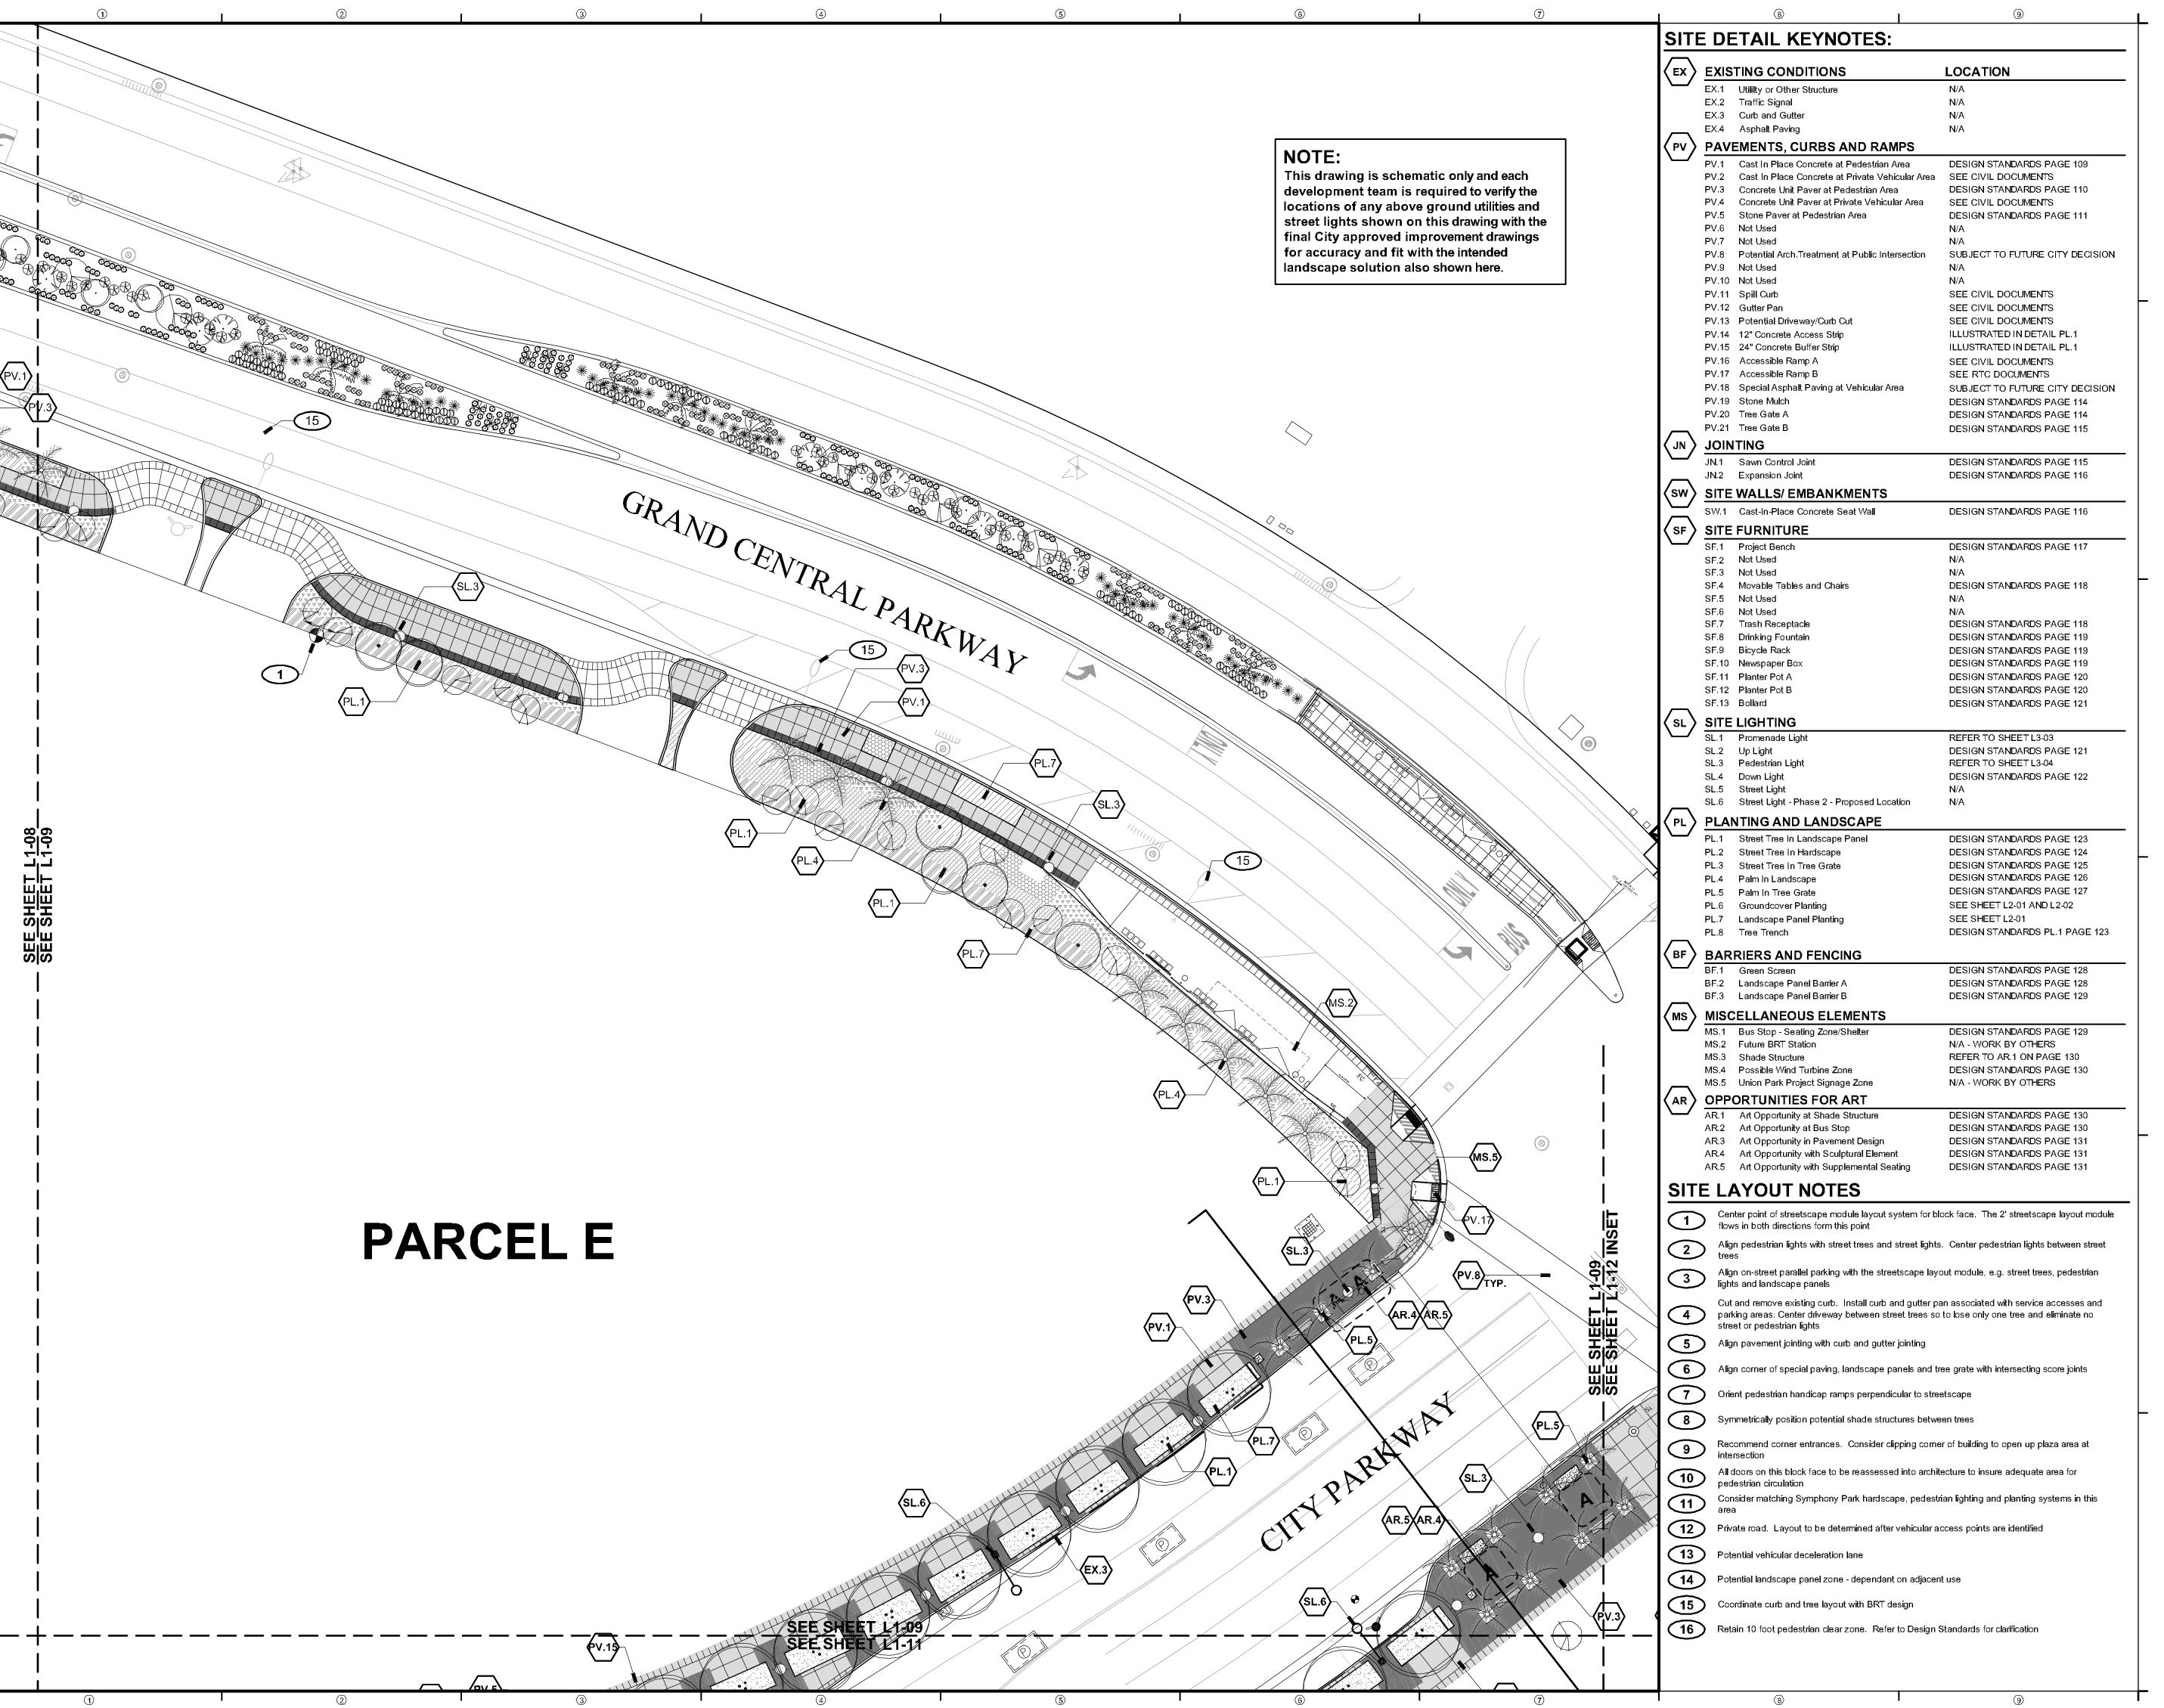

**NEWLAND COMMUNITIES** 

#### DESIGNWORKSHOP

Landscape Architecture • Land Planning
Urban Design • Tourism Planning

Asheville - Aspen - Austin - Denver


Phoenix - Salt Lake City - Tahoe


224 South 200 West Suite 150

Salt Lake City, Utah 84101 (801) 359-4771 Facsimile (801) 359-4411

 $\\ \textbf{W} \ \textbf{W} \ \textbf{W} . \textbf{D} \ \textbf{E} \ \textbf{S} \ \textbf{I} \ \textbf{G} \ \textbf{N} \ \textbf{W} \ \textbf{O} \ \textbf{R} \ \textbf{K} \ \textbf{S} \ \textbf{H} \ \textbf{O} \ \textbf{P}. \textbf{C} \ \textbf{O} \ \textbf{M}$ 

PHONY PARI

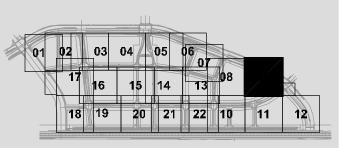

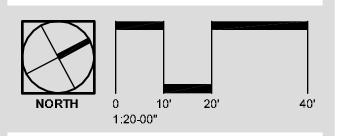

ISSUE DATE: November 9, 2007

THIS PACKAGE REPRESENTS 100% SCHEMATIC
STREETSCAPE DESIGN. THIS WORK IS COORDINATED WITH AN IN-PROGRESS ENGINEERING
BASE. THIS ENGINEERING BASE IS SUBJECT TO
CHANGE AND REFINEMENTS DO TO CITY REVIEW.
REVISIONS

#	DATE	DESCRIPTION
1	07/10/2007	PROMENADE CLEAR ZON
2	09/07/2007	PRIVATE STREET LIGHTI
3	09/07/2007	PARCEL F/G PRIVATE ST
4	11/09/2007	STREET LIGHTS
5	01/08/2008	FINAL EDITS
	10/10/0000	

6 12/12/2008 SD NOTE ADDITION
7 06/05/2009 NAME REVISIONS


### SCHEMATIC DESIGN

PROJECT NUMBER: 4035

PARCEL E (b) SITE PLAN

SHEET NUMBER

OCOPYRIGHT DESIGNWORKSHOP, IN

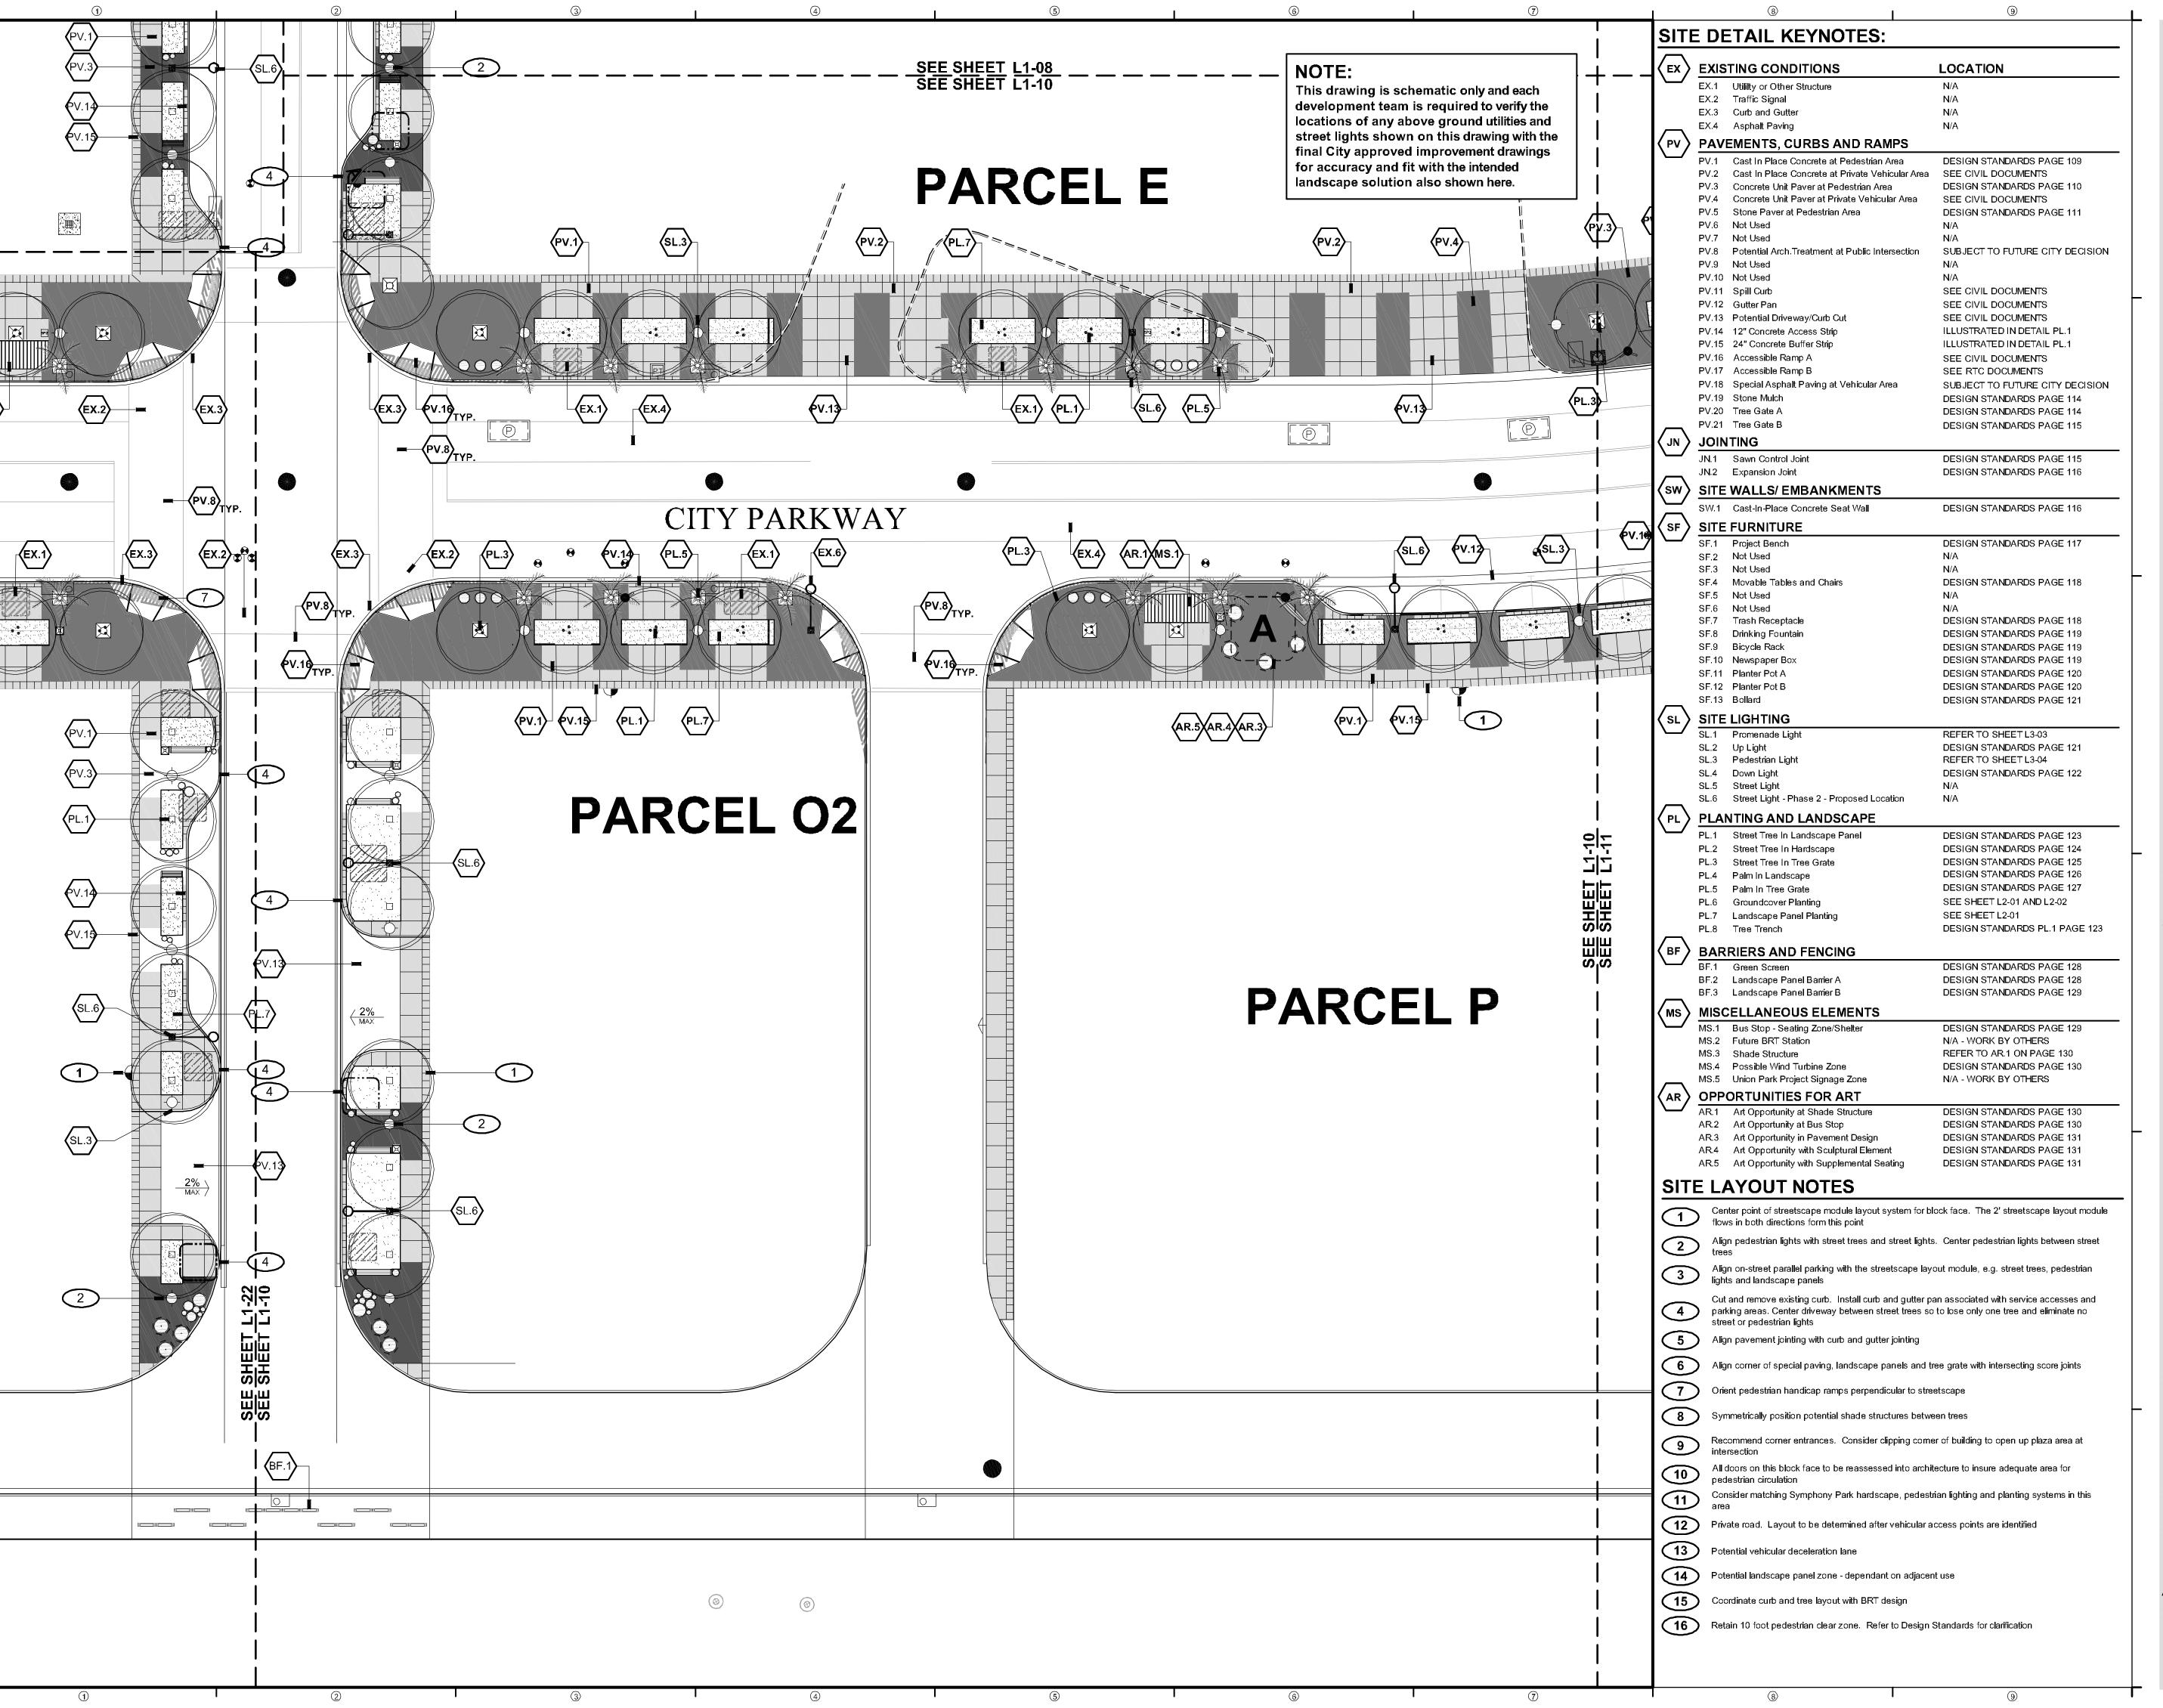

**NEWLAND COMMUNITIES** 


#### **DESIGN**WORKSHOP


Landscape Architecture • Land Planning Urban Design • Tourism Planning

> Asheville - Aspen - Austin - Denver Phoenix - Salt Lake City - Tahoe

224 South 200 West Suite 150 Salt Lake City, Utah 84101 (801) 359-4771 Facsimile (801) 359-4411

W W W.D E S I G N W O R K S H O P.C O M

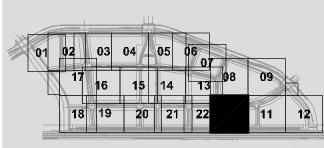

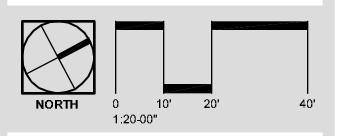

SSUE DATE: November 9, 2007 THIS PACKAGE REPRESENTS 100% SCHEMATIC ORDINATED WITH AN IN-PROGRESS ENGINEERING BASE. THIS ENGINEERING BASE IS SUBJECT TO CHANGE AND REFINEMENTS DO TO CITY REVIEW REVISIONS

1 07/10/2007 PROMENADE CLEAR ZONE 09/07/2007 PRIVATE STREET LIGHTING 3 09/07/2007 PARCEL F/G PRIVATE ST. 4 <u>11/09/2007</u> STREET LIGHTS

5 01/08/2008 FINAL EDITS


# DATE DESCRIPTION

6 12/12/2008 SD NOTE ADDITION 7 06/05/2009 NAME REVISIONS

#### SCHEMATIC DESIGN

PROJECT NUMBER: 4035

PARCEL E (c), O2 AND P (a) SITE PLAN

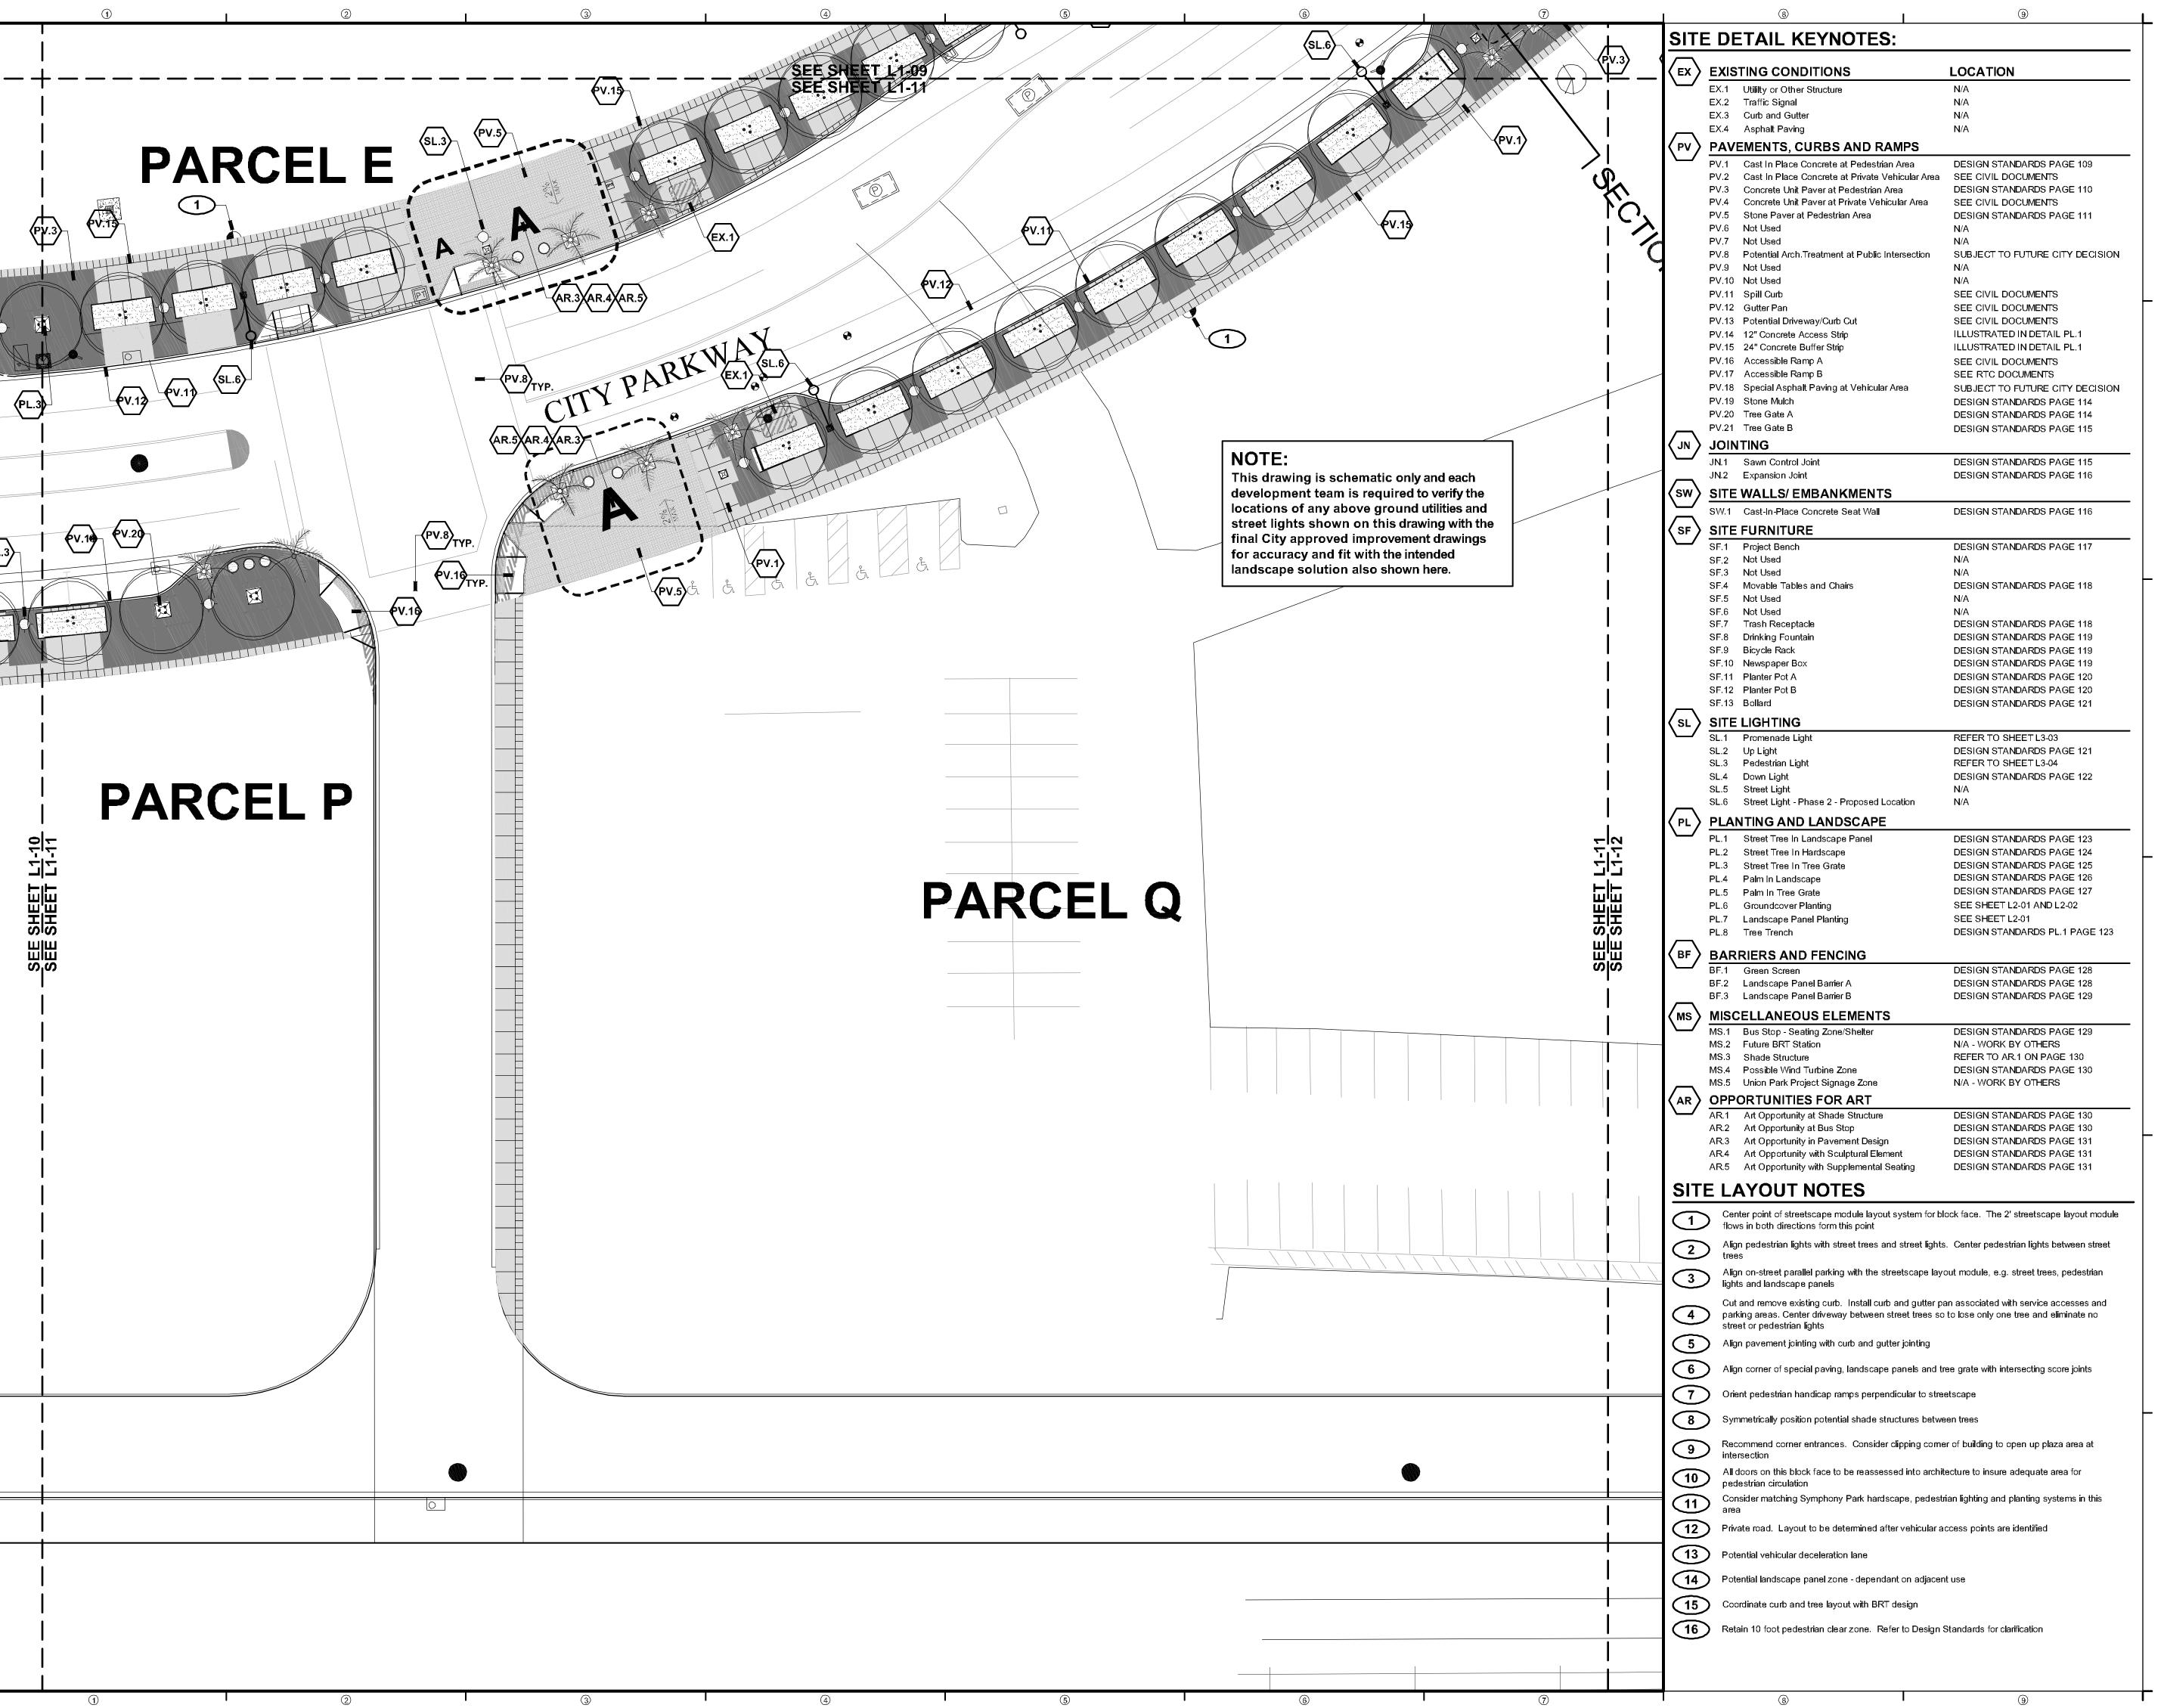

**NEWLAND COMMUNITIES** 

#### **DESIGN**WORKSHOP

Landscape Architecture • Land Planning Urban Design • Tourism Planning

> Asheville - Aspen - Austin - Denver Phoenix - Salt Lake City - Tahoe


224 South 200 West Suite 150 Salt Lake City, Utah 84101 (801) 359-4771


W W W .D E S I G N W O R K S H O P .C O M

Facsimile (801) 359-4411

MPHONY PAR

EETSCAPE SCHEMATIC DESIG

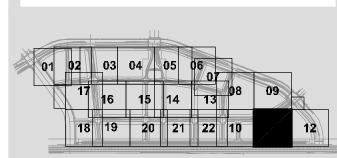

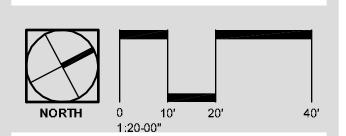

ISSUE DATE: November 9, 2007

THIS PACKAGE REPRESENTS 100% SCHEMATIC STREETSCAPE DESIGN. THIS WORK IS CO-ORDINATED WITH AN IN-PROGRESS ENGINEERING BASE. THIS ENGINEERING BASE IS SUBJECT TO CHANGE AND REFINEMENTS DO TO CITY REVIEW. REVISIONS

 1
 07/10/2007
 PROMENADE CLEAR ZONE

 2
 09/07/2007
 PRIVATE STREET LIGHTING

 3
 09/07/2007
 PARCEL F/G PRIVATE ST.

 4
 11/09/2007
 STREET LIGHTS

 5
 01/08/2008
 FINAL EDITS

# DATE DESCRIPTION

5 01/08/2008 FINAL EDITS
6 12/12/2008 SD NOTE ADDITION
7 06/05/2009 NAME REVISIONS


### SCHEMATIC DESIGN

PROJECT NUMBER: 4035

PARCEL E (d), P (b) AND Q (a) SITE PLAN

SHEET NUMBER

\_ . . .

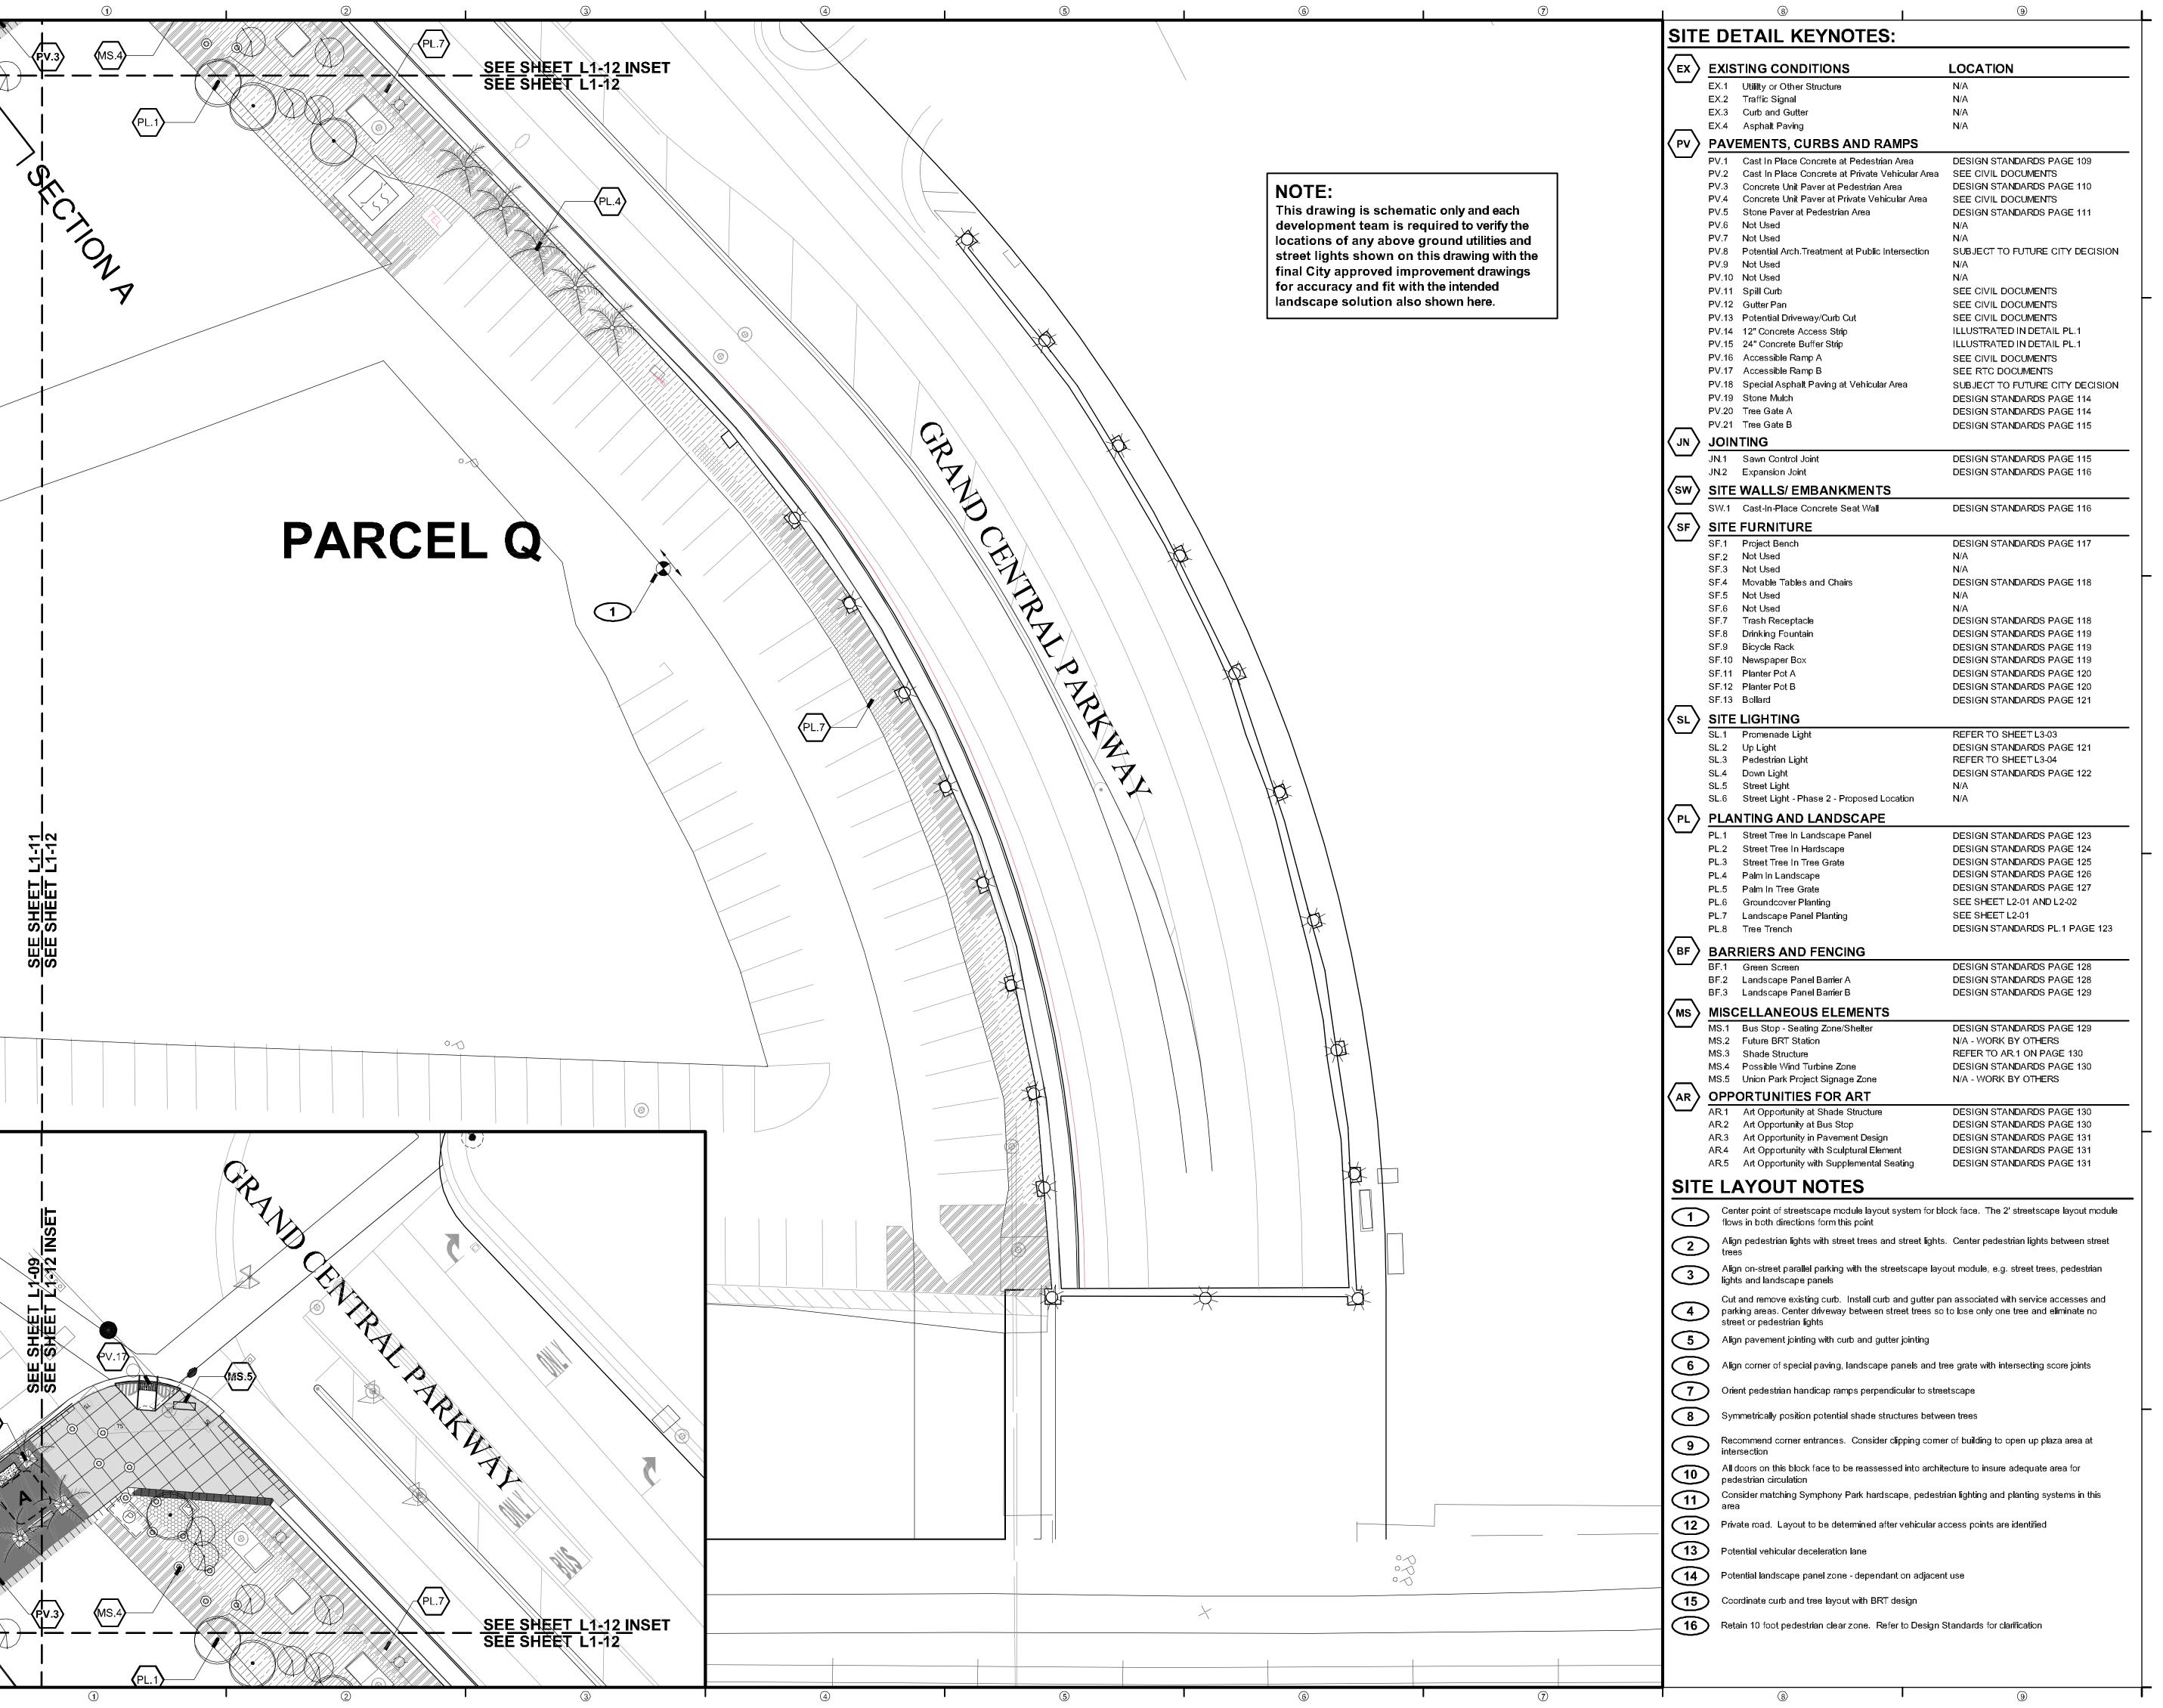

**NEWLAND COMMUNITIES** 

#### DESIGNWORKSHOP

Landscape Architecture • Land Planning
Urban Design • Tourism Planning

Asheville - Aspen - Austin - Denver Phoenix - Salt Lake City - Tahoe


224 South 200 West Suite 150 Salt Lake City, Utah 84101 (801) 359-4771


W W W.D E S I G N W O R K S H O P.C O M

Facsimile (801) 359-4411

**Y** 2

IPHONY PARI

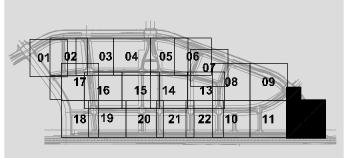

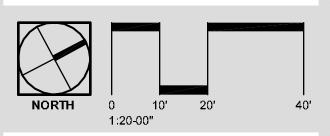

ISSUE DATE: November 9, 2007

THIS PACKAGE REPRESENTS 100% SCHEMATIC STREETSCAPE DESIGN. THIS WORK IS CO-ORDINATED WITH AN IN-PROGRESS ENGINEERING BASE. THIS ENGINEERING BASE IS SUBJECT TO CHANGE AND REFINEMENTS DO TO CITY REVIEW. REVISIONS

# DATE DESCRIPTION

4	07/40/0007	DD014E114DE 01 E4D 70
	07/10/2007	PROMENADE CLEAR ZO
2	09/07/2007	PRIVATE STREET LIGHT
3	09/07/2007	PARCEL F/G PRIVATE ST
4	11/09/2007	STREET LIGHTS
5	01/08/2008	FINAL EDITS


 6
 12/12/2008
 SD NOTE ADDITION

 7
 06/05/2009
 NAME REVISIONS

### SCHEMATIC DESIGN

PROJECT NUMBER: 4035

PARCEL Q (b) SITE PLAN

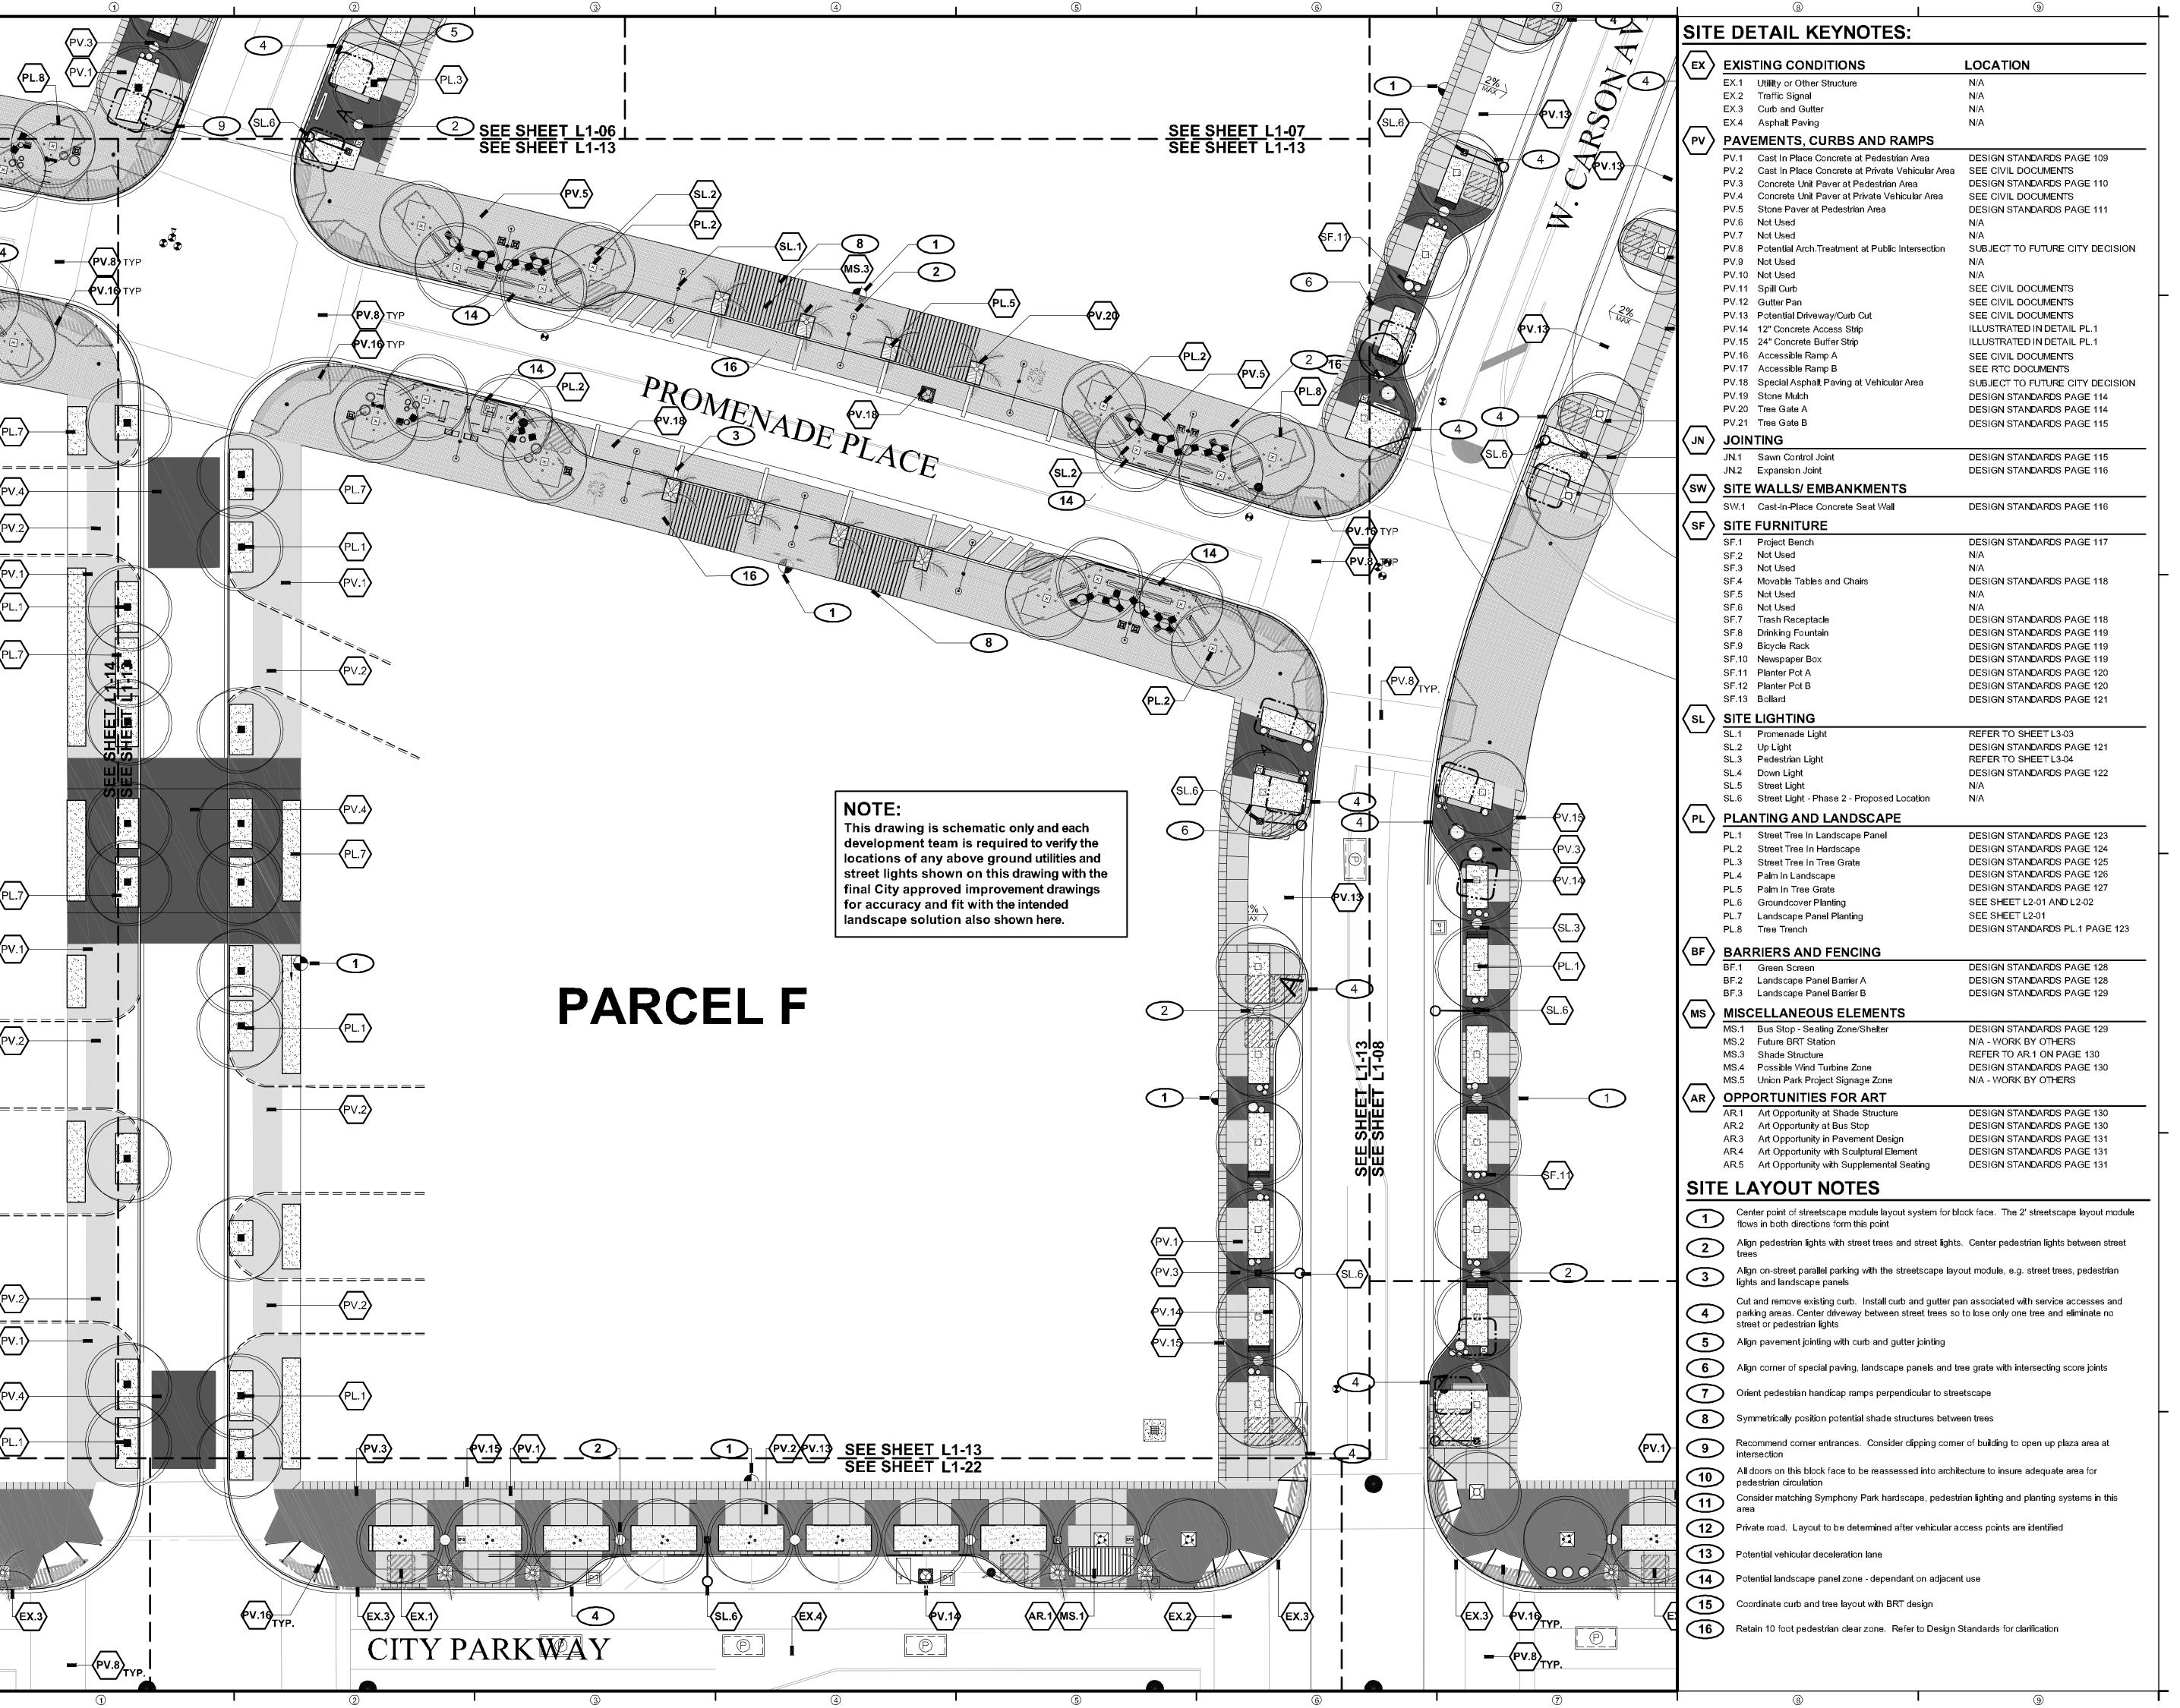

**NEWLAND COMMUNITIES** 

#### **DESIGN**WORKSHOP

Landscape Architecture • Land Planning Urban Design • Tourism Planning


> Asheville - Aspen - Austin - Denver Phoenix - Salt Lake City - Tahoe


224 South 200 West Suite 150 Salt Lake City, Utah 84101

Facsimile (801) 359-4411

(801) 359-4771

W W W.D E S I G N W O R K S H O P.C O M

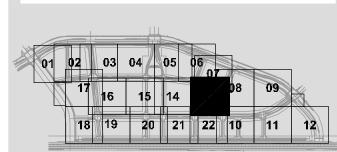

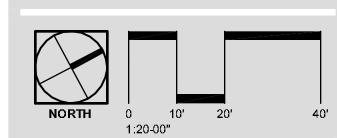

SSUE DATE: November 9, 2007 THIS PACKAGE REPRESENTS 100% SCHEMATIC ORDINATED WITH AN IN-PROGRESS ENGINEERING BASE. THIS ENGINEERING BASE IS SUBJECT TO CHANGE AND REFINEMENTS DO TO CITY REVIEW REVISIONS


1	07/10/2007	PROMENADE CLEAR ZO
2	09/07/2007	PRIVATE STREET LIGH
3	09/07/2007	PARCEL F/G PRIVATE S
4	11/09/2007	STREET LIGHTS
5	01/08/2008	FINAL EDITS

6 12/12/2008 SD NOTE ADDITION 7 06/05/2009 NAME REVISIONS

#### SCHEMATIC DESIGN

PROJECT NUMBER: 4035

PARCEL F SITE PLAN

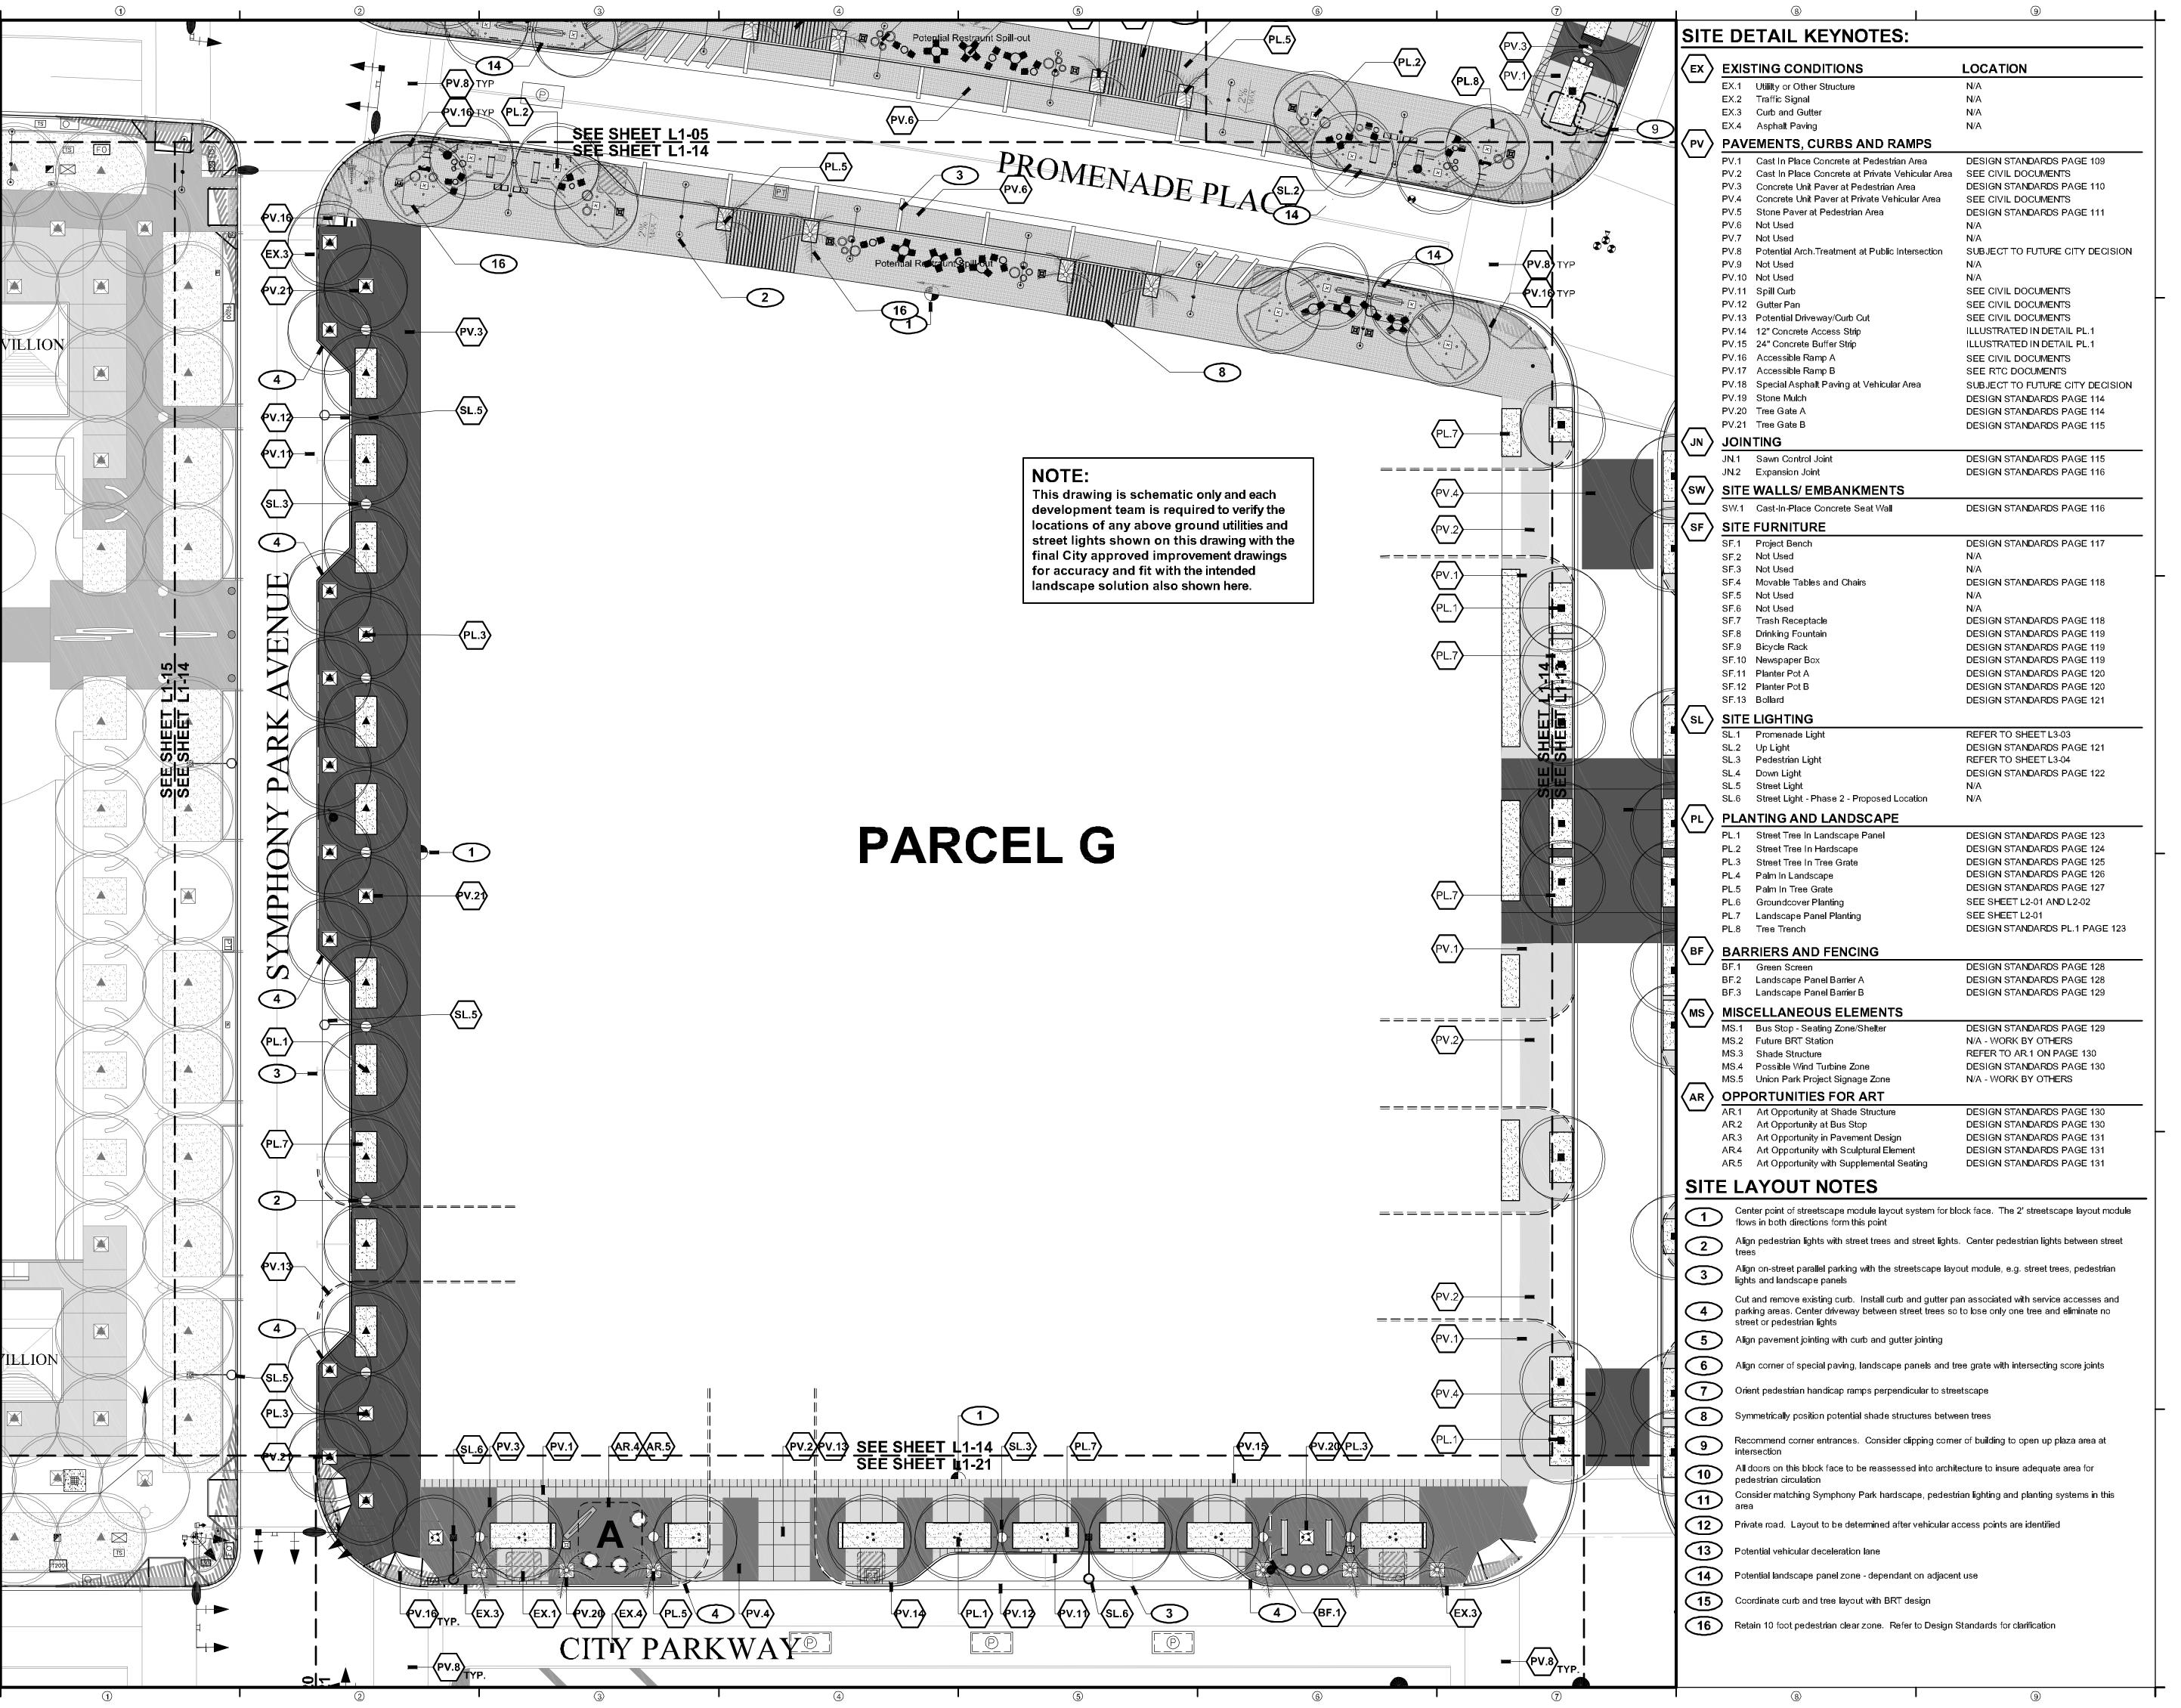

**NEWLAND COMMUNITIES** 

#### **DESIGN**WORKSHOP

Landscape Architecture • Land Planning
Urban Design • Tourism Planning

Asheville - Aspen - Austin - Denver Phoenix - Salt Lake City - Tahoe


224 South 200 West Suite 150 Salt Lake City, Utah 84101 (801) 359-4771


W W W.D E S I G N W O R K S H O P.C O M

Facsimile (801) 359-4411

### **Y** 2

MPHONY PARK
RETSCAPE SCHEMATIC DESIGN

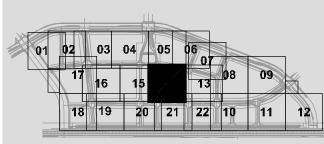

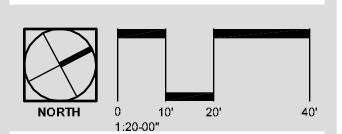

ISSUE DATE: November 9, 2007

THIS PACKAGE REPRESENTS 100% SCHEMATIC STREETSCAPE DESIGN. THIS WORK IS CO-ORDINATED WITH AN IN-PROGRESS ENGINEERING BASE. THIS ENGINEERING BASE IS SUBJECT TO CHANGE AND REFINEMENTS DO TO CITY REVIEW. REVISIONS

 1
 07/10/2007
 PROMENADE CLEAR ZONE

 2
 09/07/2007
 PRIVATE STREET LIGHTING

 3
 09/07/2007
 PARCEL F/G PRIVATE ST.

 4
 11/09/2007
 STREET LIGHTS

 5
 01/08/2008
 FINAL EDITS

# DATE DESCRIPTION

5 01/08/2008 FINAL EDITS
6 12/12/2008 SD NOTE ADDITION
7 06/05/2009 NAME REVISIONS


### SCHEMATIC DESIGN

PROJECT NUMBER: 4035

PARCEL G SITE PLAN

SHEET NUMBER

COPYRIGHT DESIGNWORKSHOP, INC.

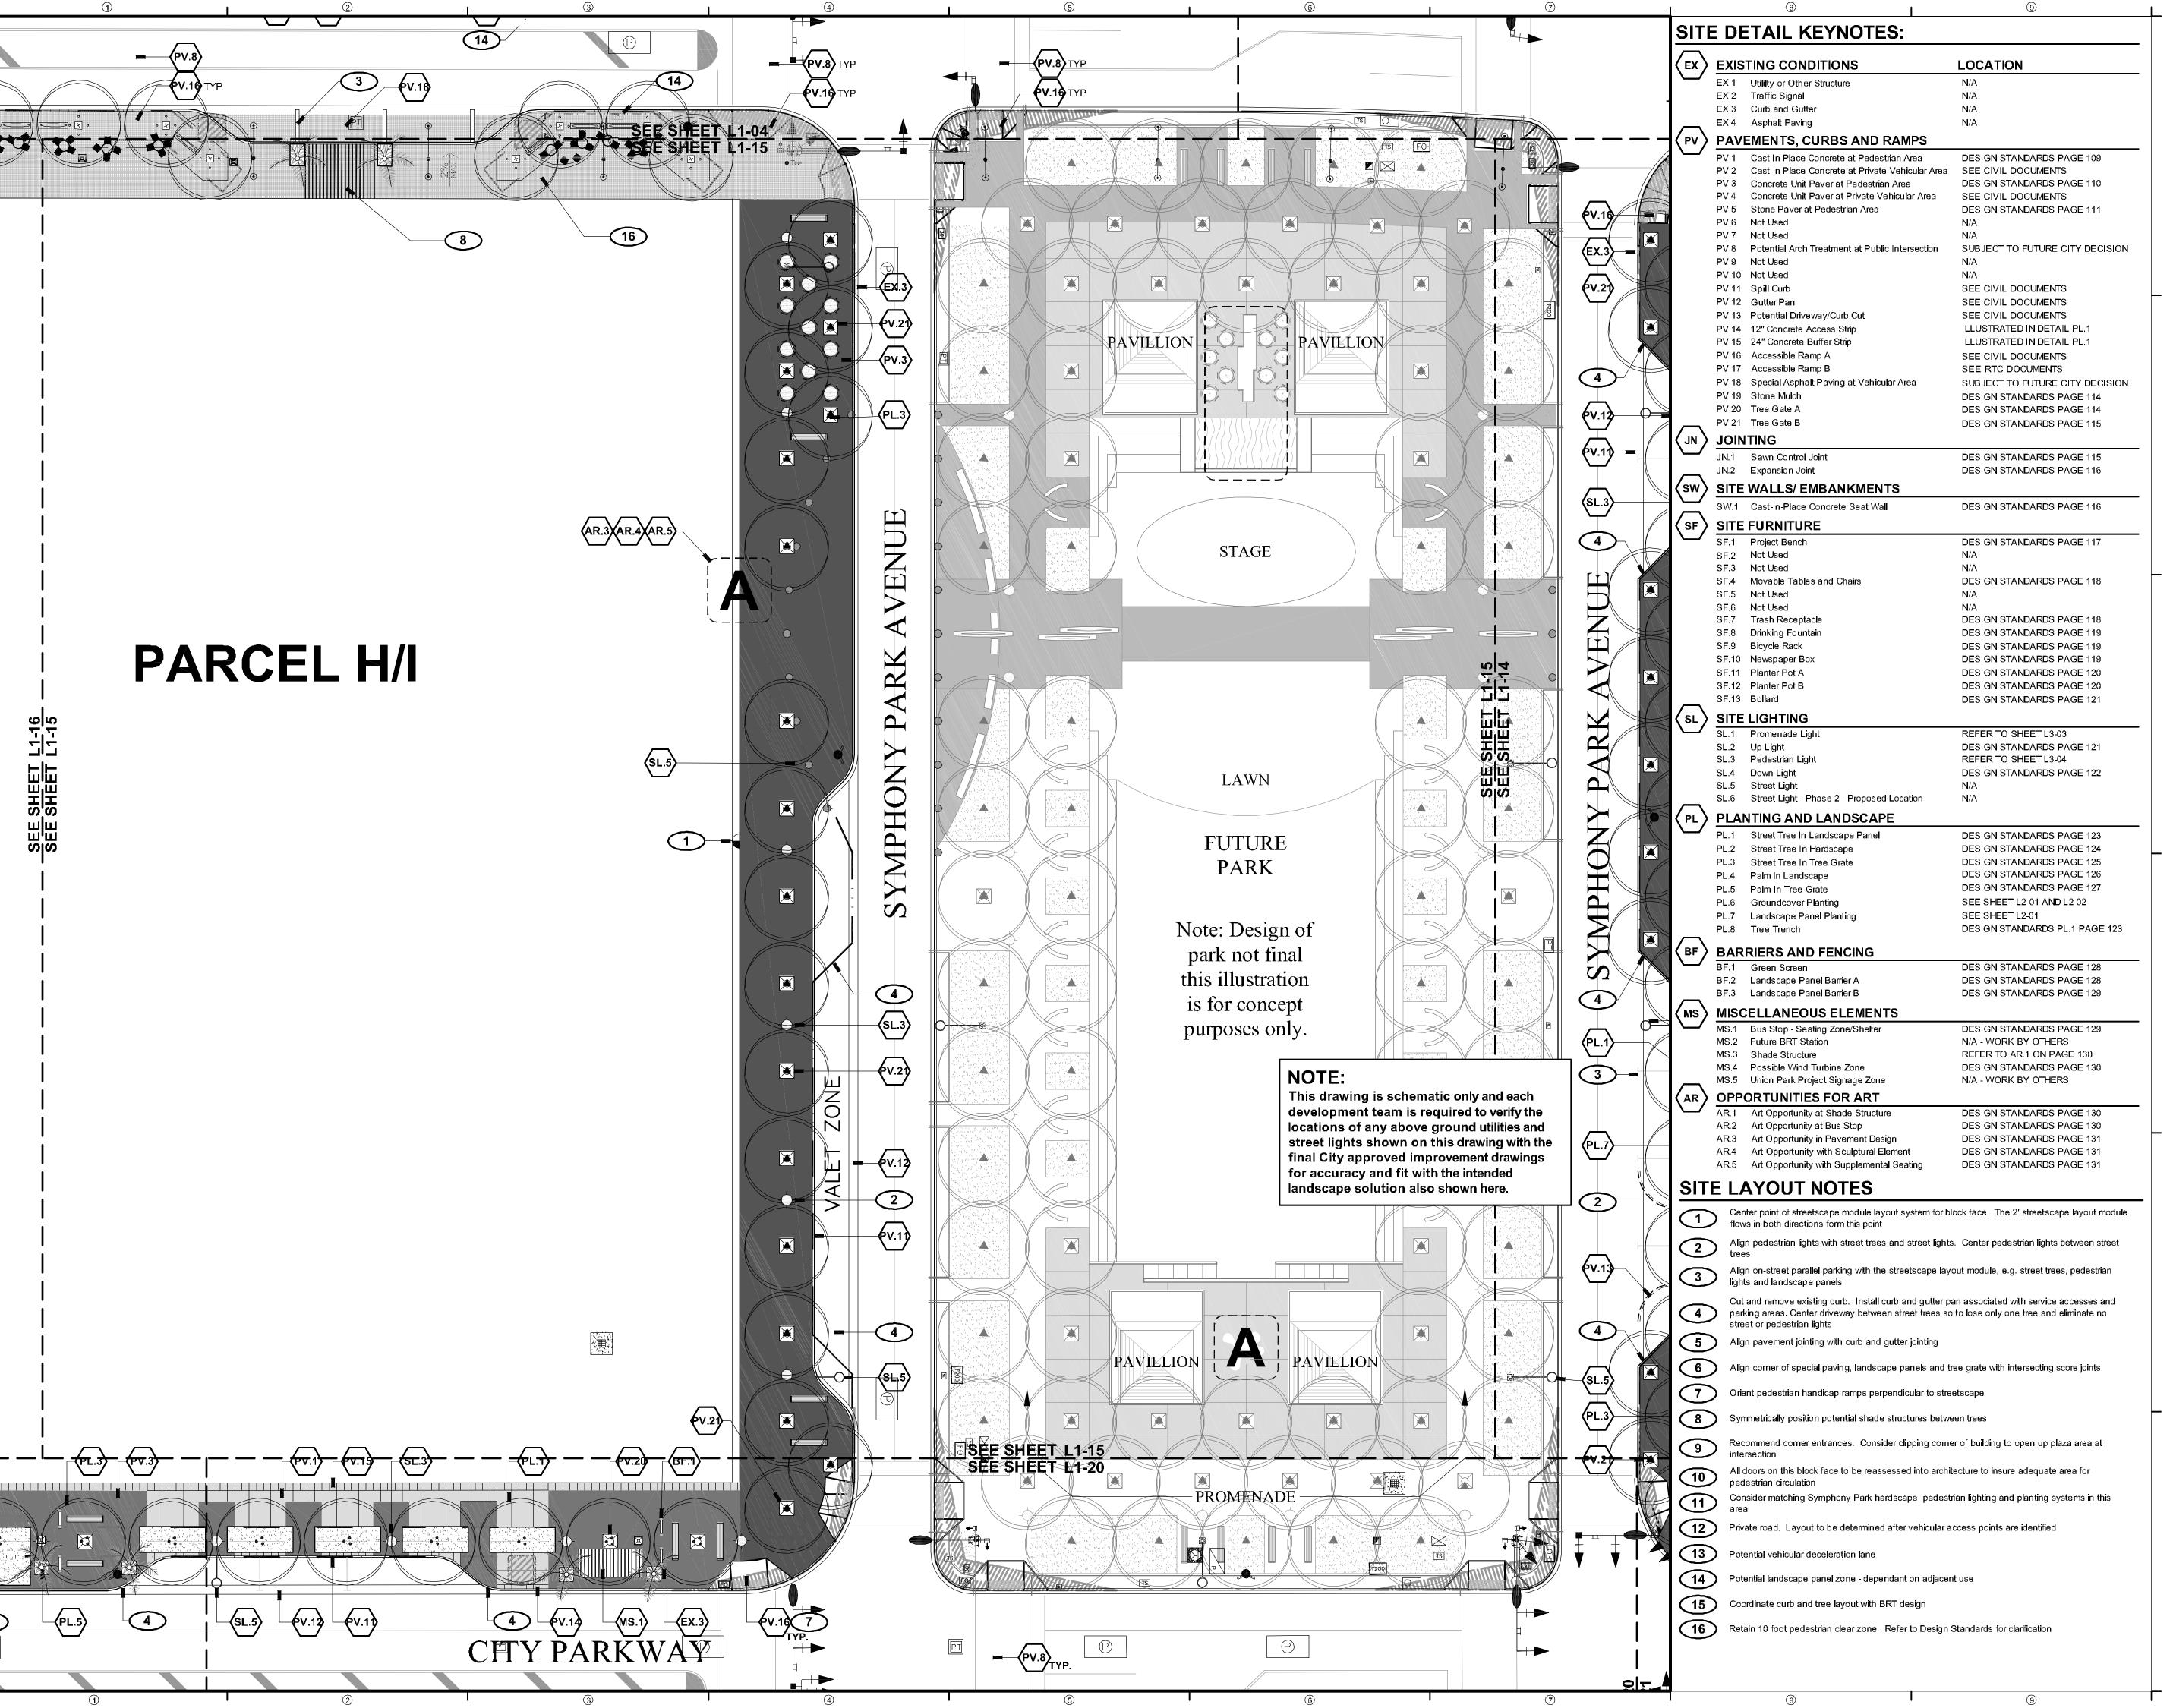

**NEWLAND COMMUNITIES** 

#### **DESIGN**WORKSHOP

Landscape Architecture • Land Planning Urban Design • Tourism Planning


> Asheville - Aspen - Austin - Denver Phoenix - Salt Lake City - Tahoe


224 South 200 West Suite 150 Salt Lake City, Utah 84101 (801) 359-4771 Facsimile (801) 359-4411

 $\\ \textbf{W} \ \textbf{W} \ \textbf{W} . \textbf{D} \ \textbf{E} \ \textbf{S} \ \textbf{I} \ \textbf{G} \ \textbf{N} \ \textbf{W} \ \textbf{O} \ \textbf{R} \ \textbf{K} \ \textbf{S} \ \textbf{H} \ \textbf{O} \ \textbf{P}. \textbf{C} \ \textbf{O} \ \textbf{M}$ 

### ARK DESIGN

STREETSCAPE SCHEMATIC DE

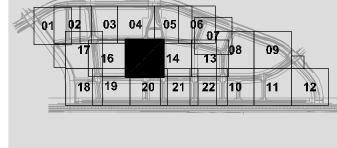

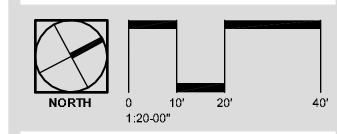

ISSUE DATE: November 9, 2007

THIS PACKAGE REPRESENTS 100% SCHEMATIC
STREETSCAPE DESIGN. THIS WORK IS COORDINATED WITH AN IN-PROGRESS ENGINEERING
BASE. THIS ENGINEERING BASE IS SUBJECT TO
CHANGE AND REFINEMENTS DO TO CITY REVIEW.
REVISIONS

# DATE DESCRIPTION

1 07/10/2007 PROMENADE CLEAR ZONE
2 09/07/2007 PRIVATE STREET LIGHTING
3 09/07/2007 PARCEL F/G PRIVATE ST.
4 11/09/2007 STREET LIGHTS
5 01/08/2008 FINAL EDITS

5 01/08/2008 FINAL EDITS
6 12/12/2008 SD NOTE ADDITIO

 6
 12/12/2008
 SD NOTE ADDITION

 7
 06/05/2009
 NAME REVISIONS

### SCHEMATIC DESIGN


PROJECT NUMBER: 4035

PARCEL H/I (a) AND M3 SITE PLAN

SHEET NUMBER

L1-15

O COPYRIGHT DESIGNWORKSHOP, INC.

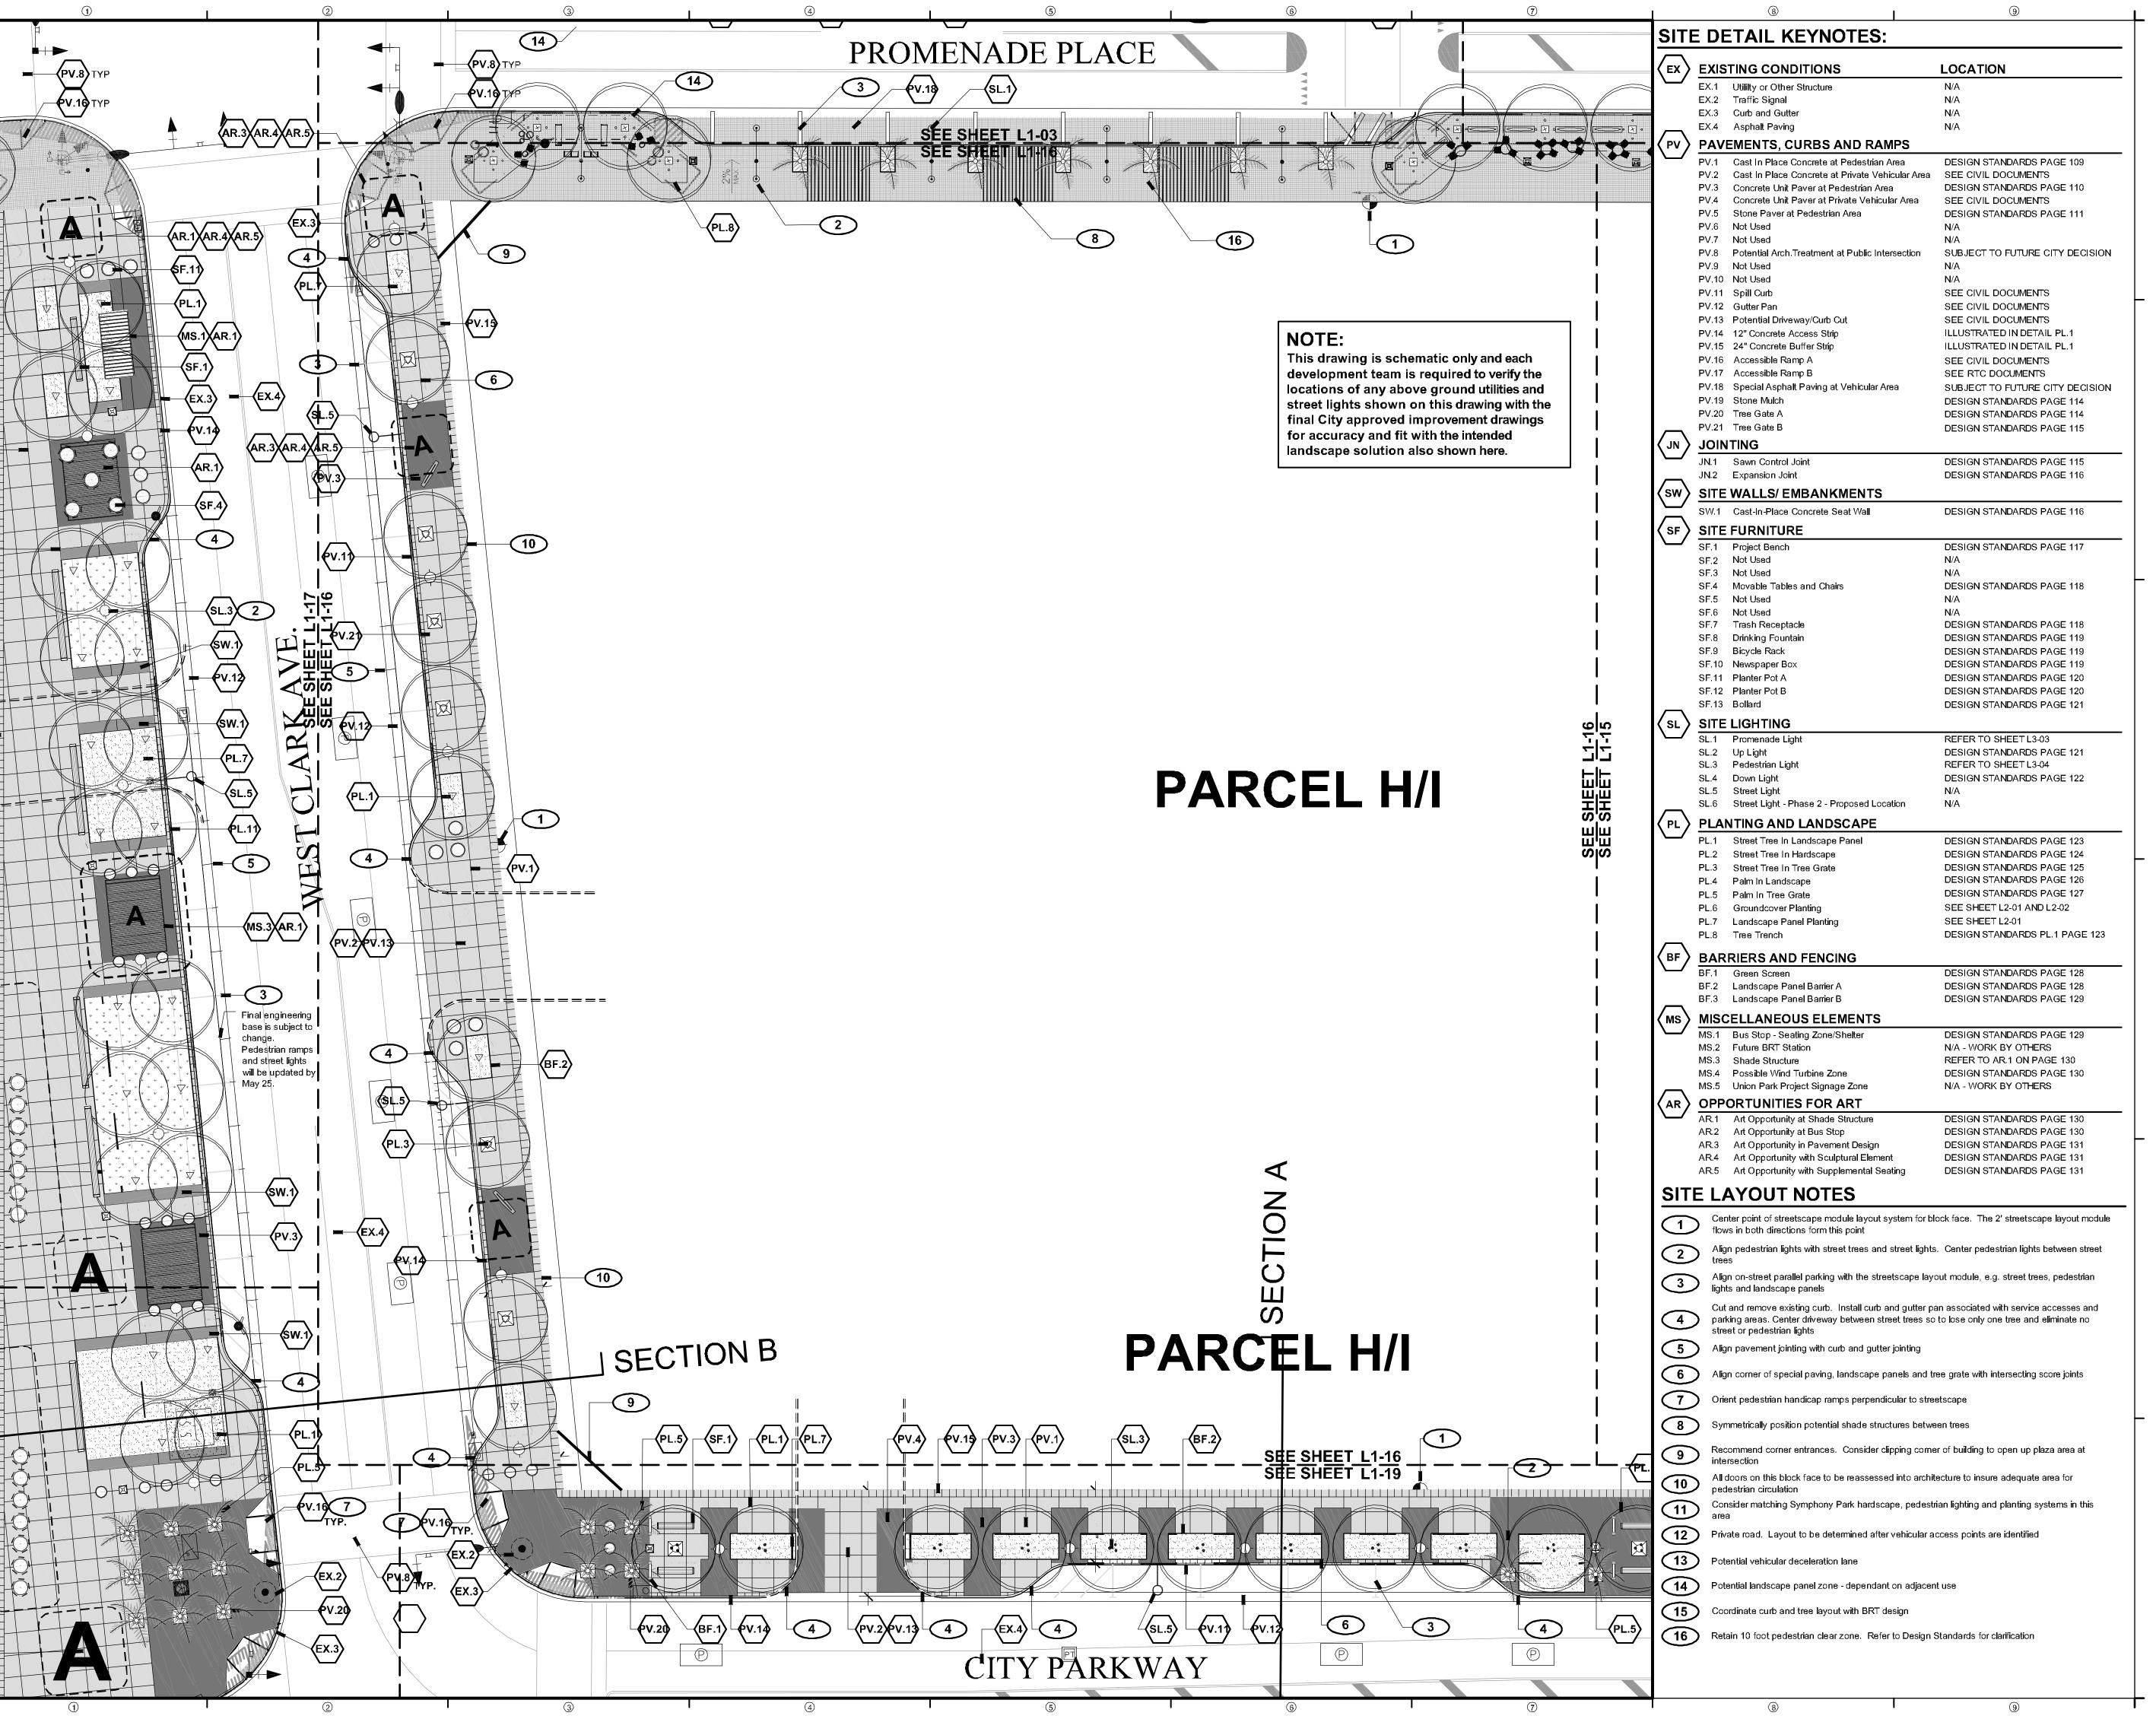

**NEWLAND COMMUNITIES** 


#### **DESIGN**WORKSHOP


Landscape Architecture • Land Planning Urban Design • Tourism Planning

> Asheville - Aspen - Austin - Denver Phoenix - Salt Lake City - Tahoe

224 South 200 West Suite 150 Salt Lake City, Utah 84101 (801) 359-4771 Facsimile (801) 359-4411

W W W D E S I G N W O R K S H O P C O M

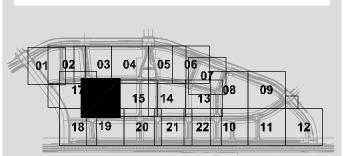

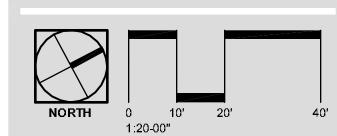

SSUE DATE: November 9, 2007 THIS PACKAGE REPRESENTS 100% SCHEMATIC ORDINATED WITH AN IN-PROGRESS ENGINEERING BASE. THIS ENGINEERING BASE IS SUBJECT TO CHANGE AND REFINEMENTS DO TO CITY REVIEW REVISIONS

1	07/10/2007	PROMENADE CLEAR
2	09/07/2007	PRIVATE STREET LI
3	09/07/2007	PARCEL F/G PRIVAT
4	11/09/2007	STREET LIGHTS
5	01/08/2008	FINAL EDITS


# DATE DESCRIPTION

6 12/12/2008 SD NOTE ADDITION 7 06/05/2009 NAME REVISIONS

#### SCHEMATIC DESIGN

PROJECT NUMBER: 4035

PARCEL H/I (b) SITE PLAN

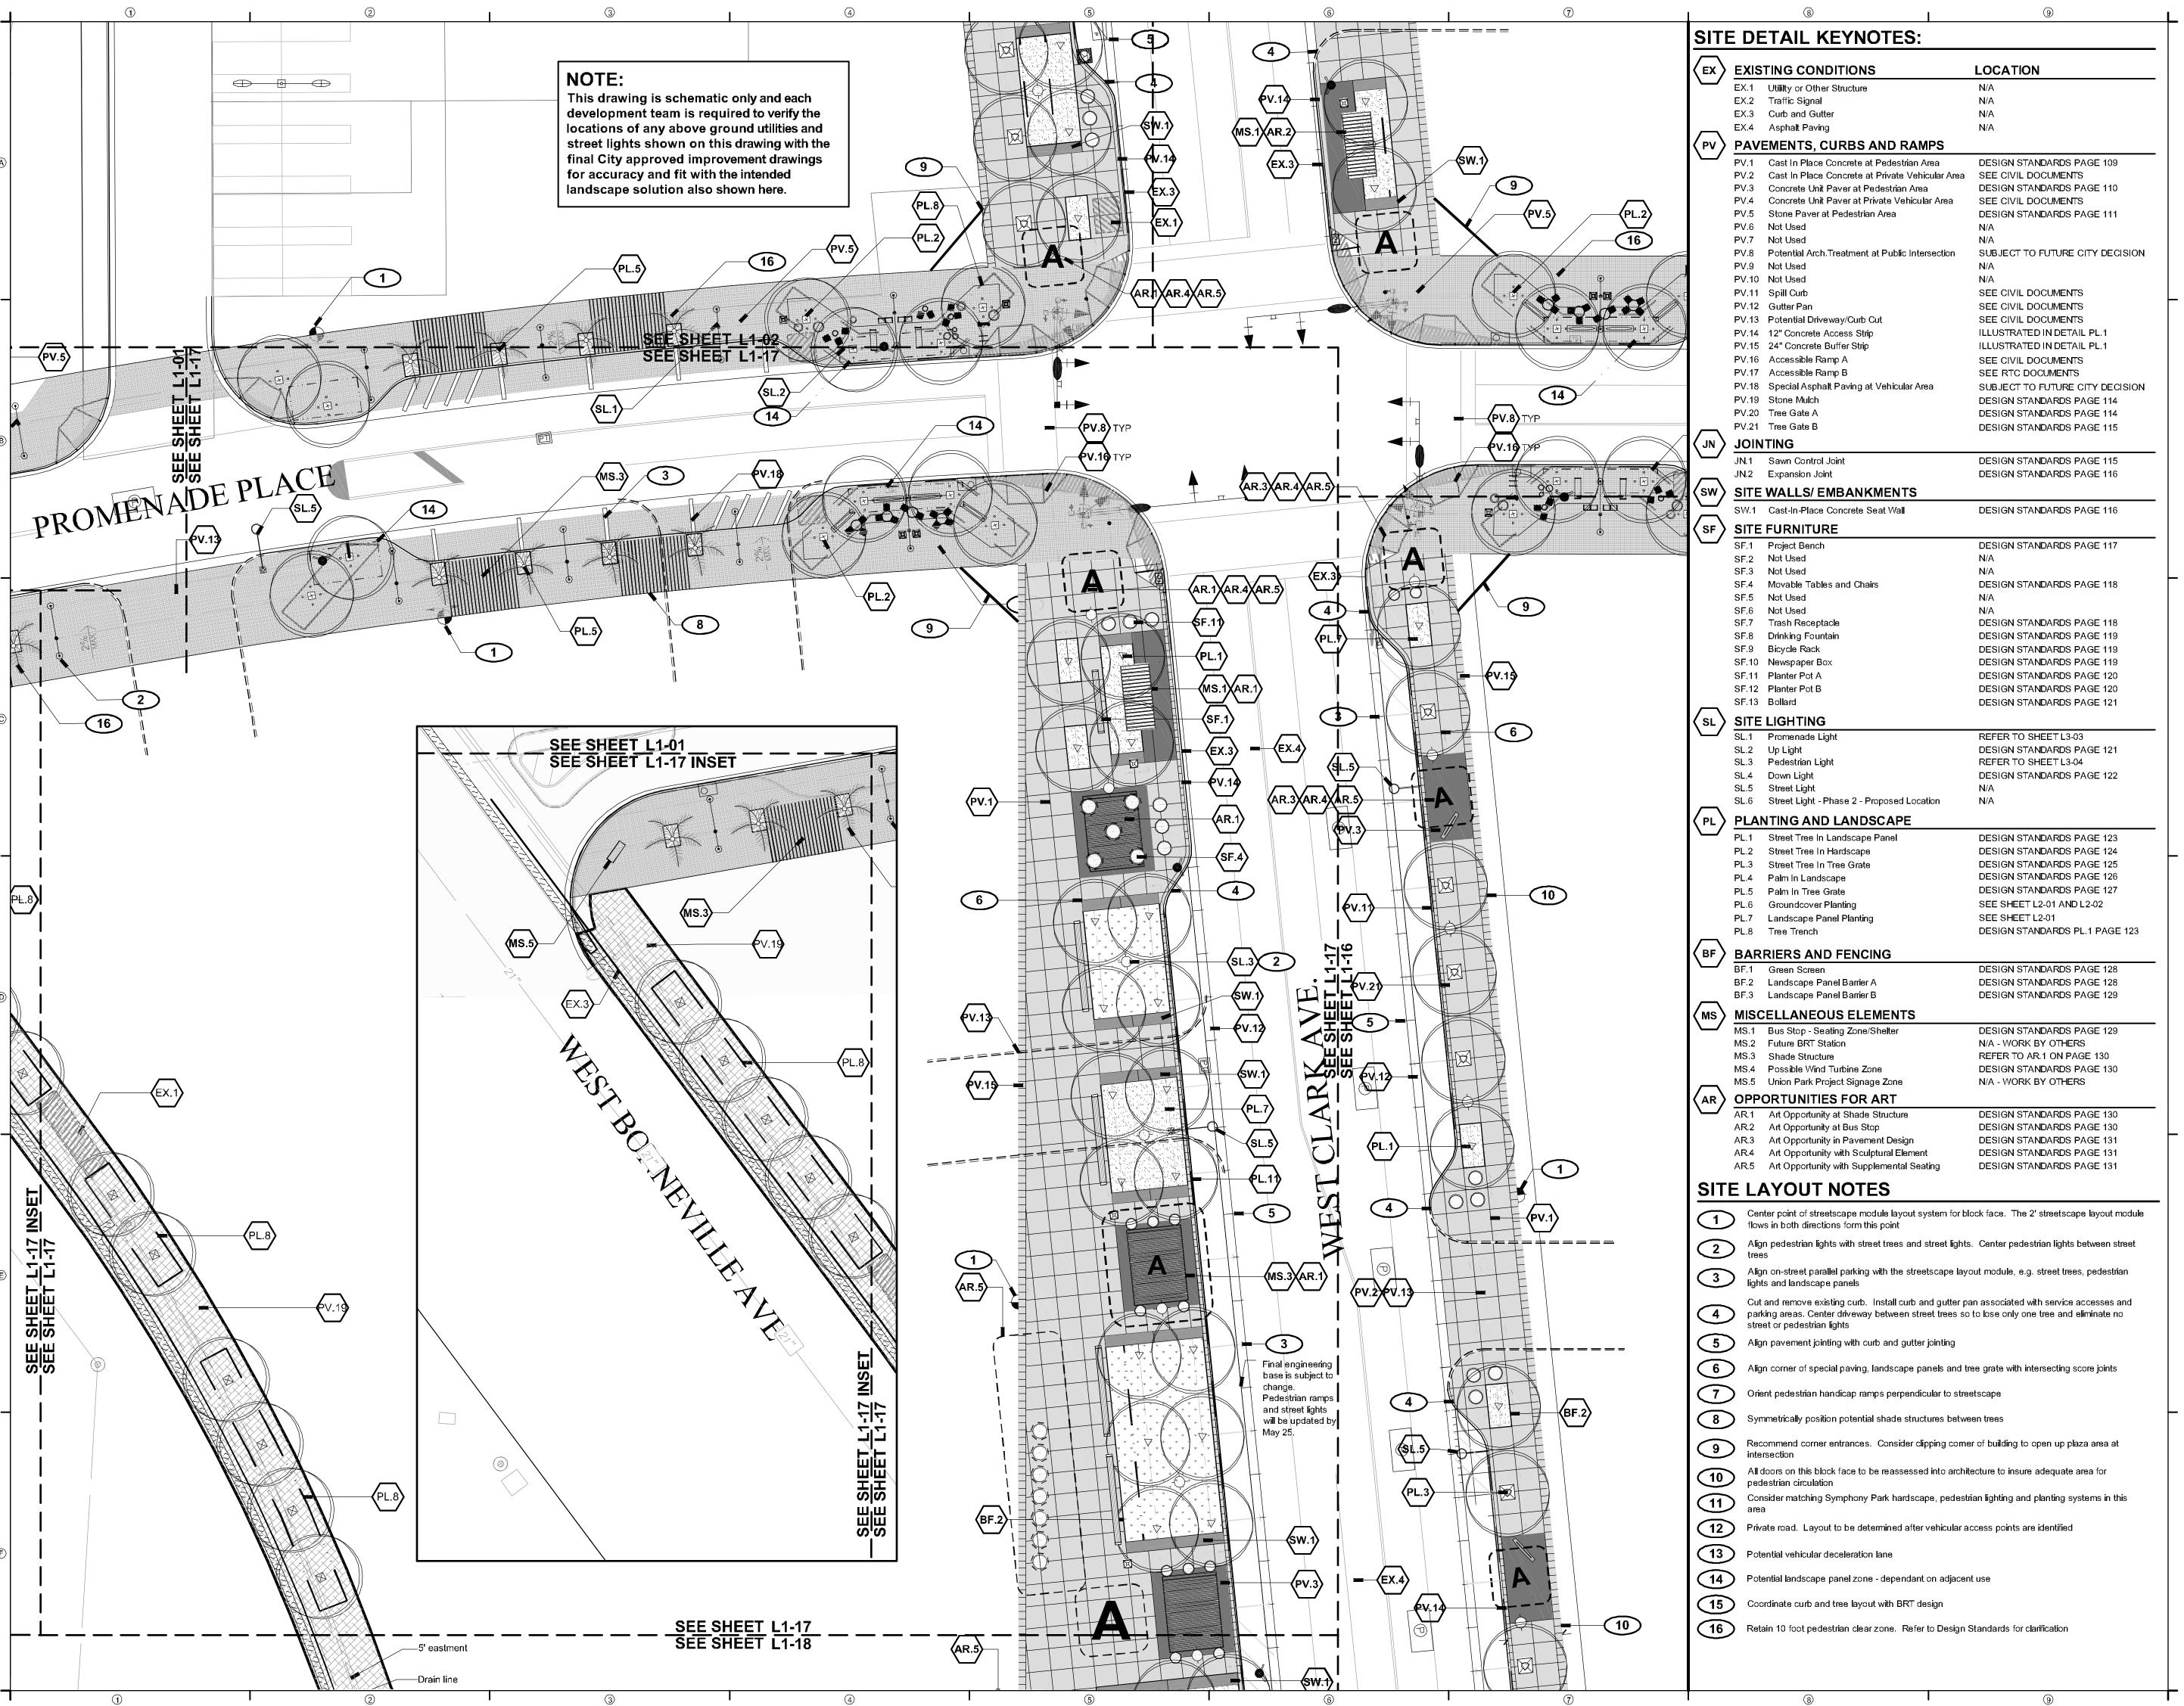

**NEWLAND COMMUNITIES** 

#### **DESIGN**WORKSHOP

Landscape Architecture • Land Planning
Urban Design • Tourism Planning


Asheville - Aspen - Austin - Denver Phoenix - Salt Lake City - Tahoe


224 South 200 West Suite 150 Salt Lake City, Utah 84101 (801) 359-4771

Facsimile (801) 359-4411

W W W.D E S I G N W O R K S H O P.C O M

PHONY PARPISCAPE SCHEMATIC DESIGN

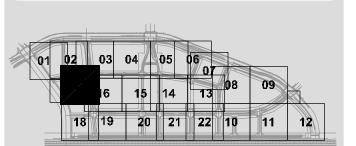

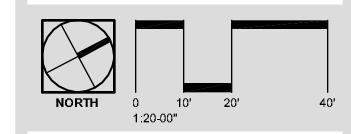

ISSUE DATE: November 9, 2007

THIS PACKAGE REPRESENTS 100% SCHEMATIC STREETSCAPE DESIGN. THIS WORK IS CO-ORDINATED WITH AN IN-PROGRESS ENGINEERING BASE. THIS ENGINEERING BASE IS SUBJECT TO CHANGE AND REFINEMENTS DO TO CITY REVIEW. REVISIONS

# DATE DESCRIPTION

 1
 07/10/2007
 PROMENADE CLEAR ZONE

 2
 09/07/2007
 PRIVATE STREET LIGHTING

 3
 09/07/2007
 PARCEL F/G PRIVATE ST.

 4
 11/09/2007
 STREET LIGHTS


 5
 01/08/2008
 FINAL EDITS

6 12/12/2008 SD NOTE ADDITION
7 06/05/2009 NAME REVISIONS

### SCHEMATIC DESIGN

PROJECT NUMBER: 4035

PARCEL J (a) SITE PLAN

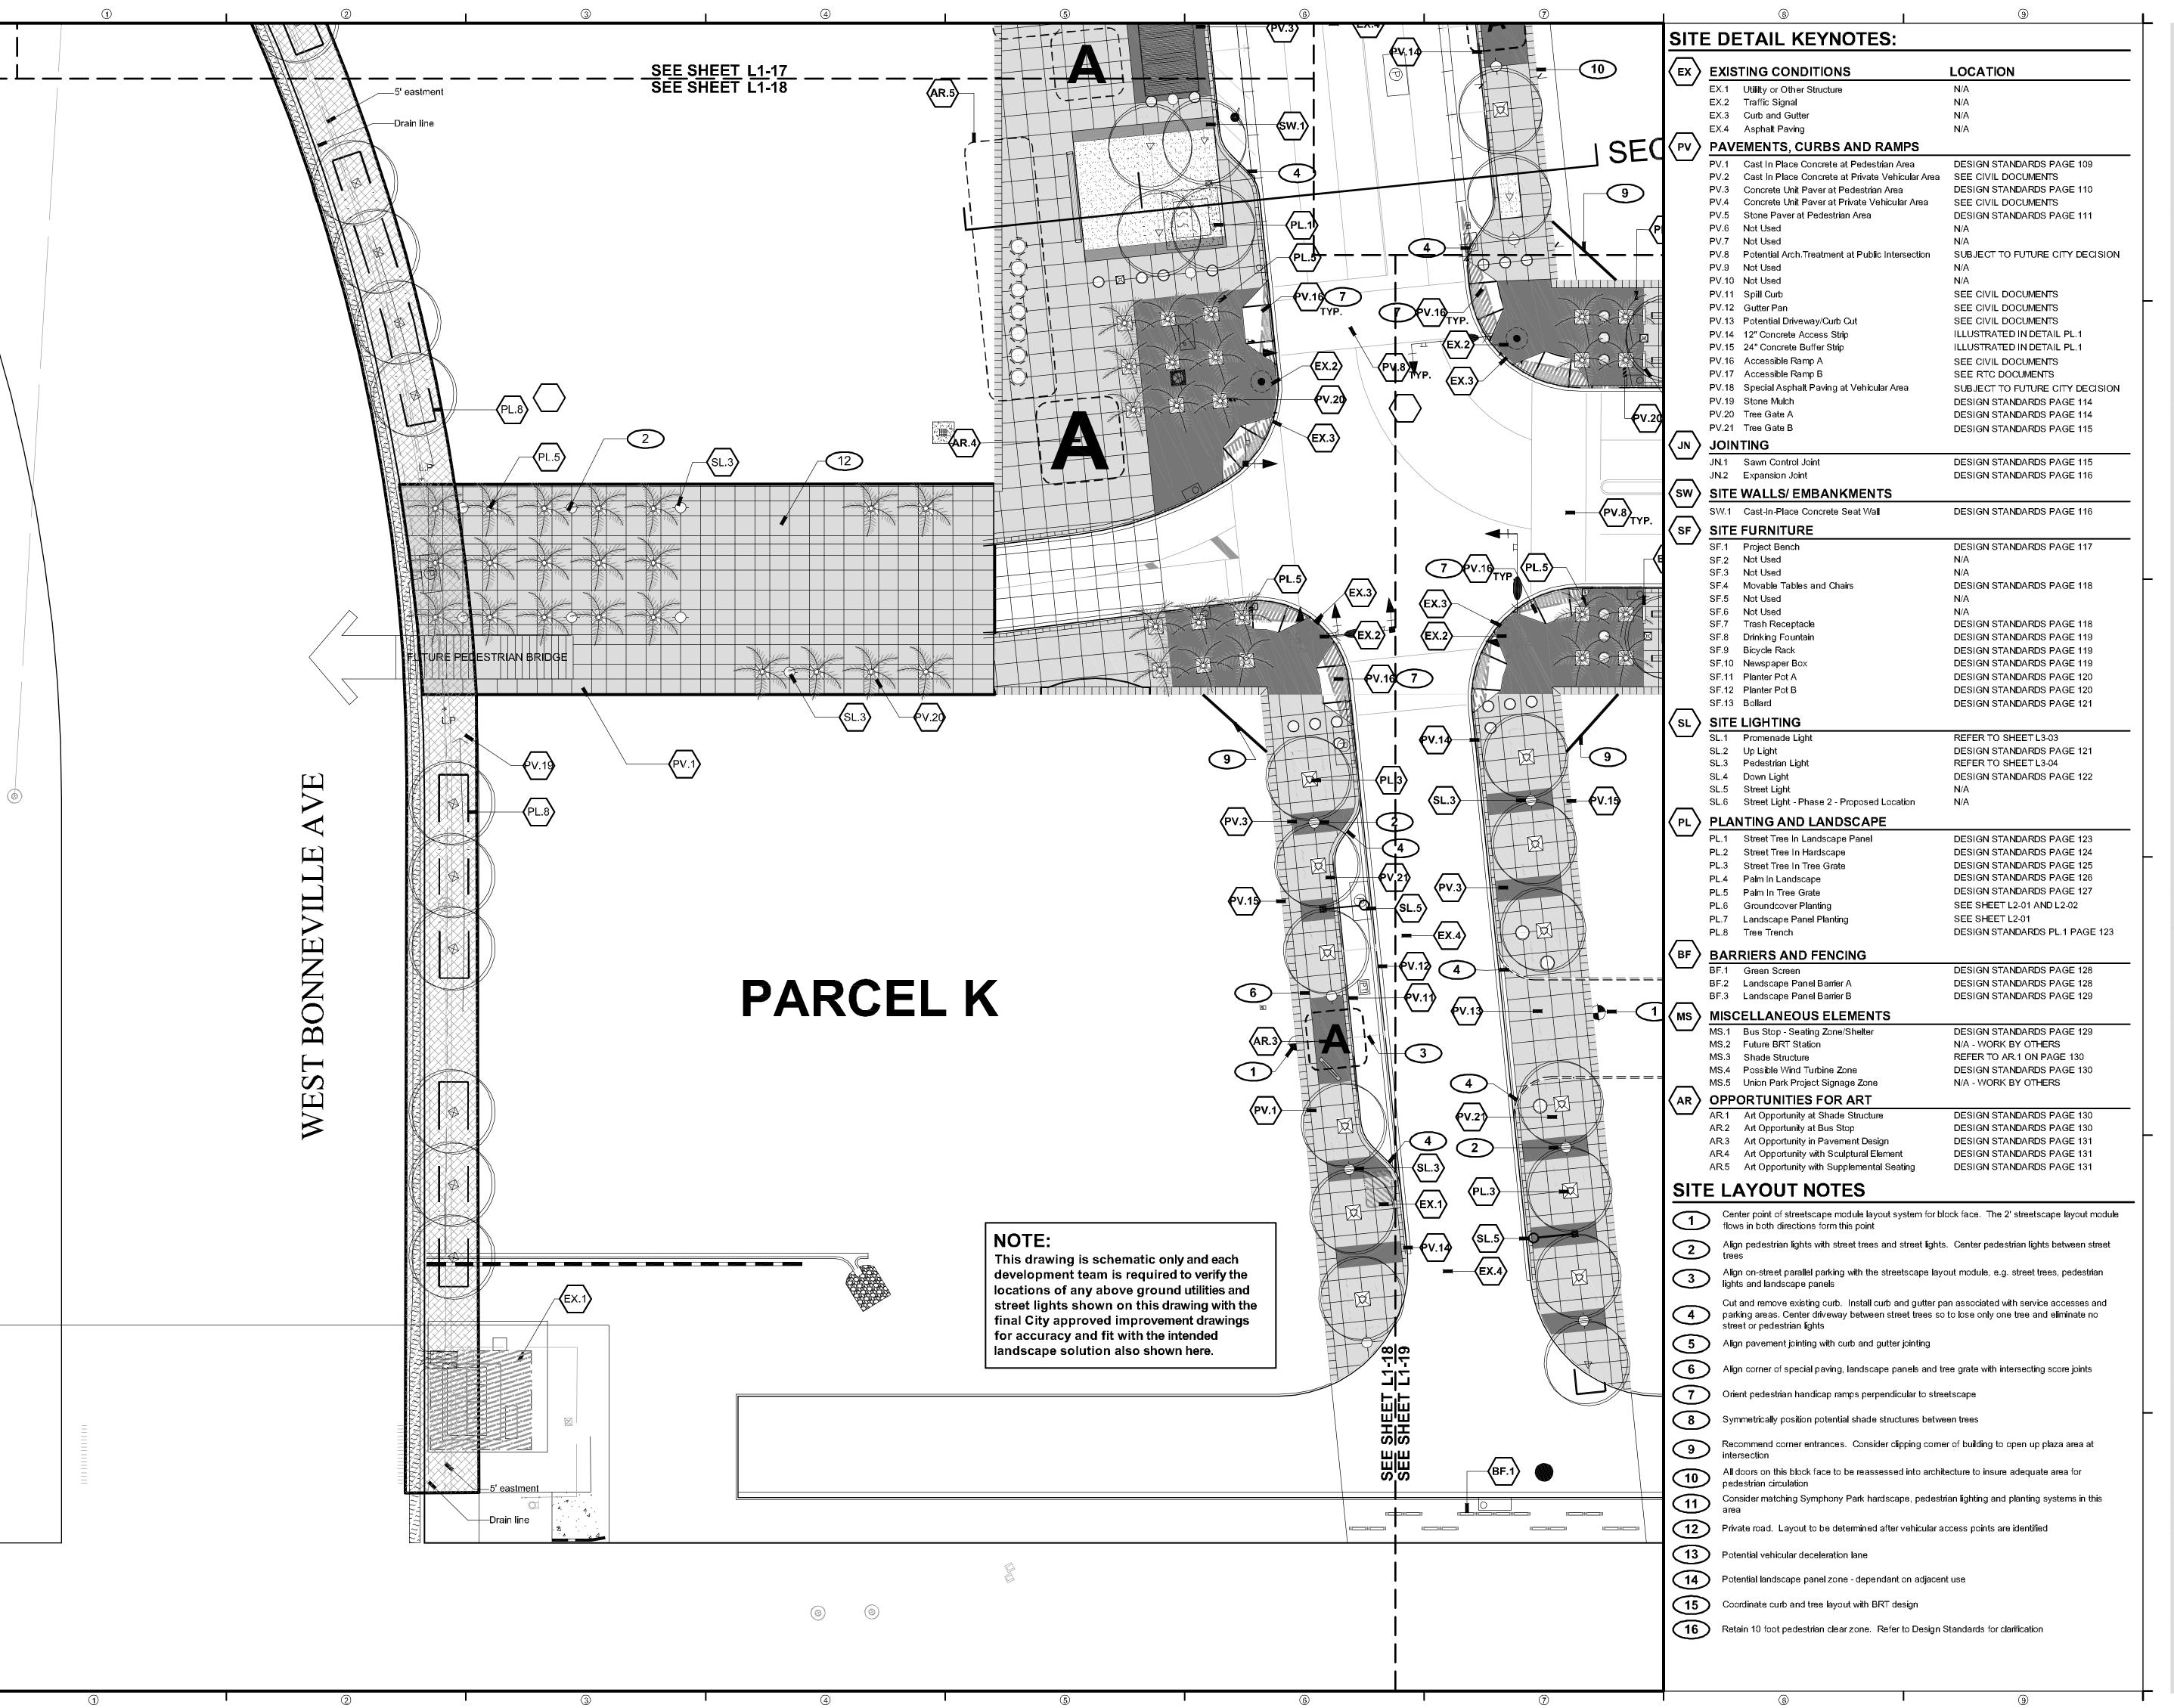

**NEWLAND COMMUNITIES** 

#### **DESIGN**WORKSHOP

Landscape Architecture • Land Planning
Urban Design • Tourism Planning

-Asheville - Aspen - Austin - Denver Phoenix - Salt Lake City - Tahoe


224 South 200 West Suite 150 Salt Lake City, Utah 84101 (801) 359-4771


W W W.D E S I G N W O R K S H O P.C O M

Facsimile (801) 359-4411

**Y** =

CAPE SCHEMATIC DESIGN

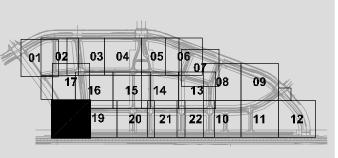

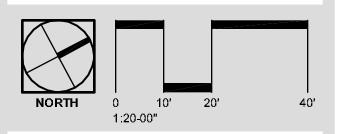

ISSUE DATE: November 9, 2007

THIS PACKAGE REPRESENTS 100% SCHEMATIC STREETSCAPE DESIGN. THIS WORK IS CO-ORDINATED WITH AN IN-PROGRESS ENGINEERING BASE. THIS ENGINEERING BASE IS SUBJECT TO CHANGE AND REFINEMENTS DO TO CITY REVIEW. REVISIONS

 1
 07/10/2007
 PROMENADE CLEAR ZONE

 2
 09/07/2007
 PRIVATE STREET LIGHTING

 3
 09/07/2007
 PARCEL F/G PRIVATE ST.

 4
 11/09/2007
 STREET LIGHTS

 5
 01/08/2008
 FINAL EDITS

 5
 01/08/2008
 FINAL EDITS

 6
 12/12/2008
 SD NOTE ADDITION

 7
 06/05/2009
 NAME REVISIONS

# DATE DESCRIPTION


SCHEMATIC DESIGN

PROJECT NUMBER: 4035

PARCEL J (b) AND K SITE PLAN

SHEET NUMBER

L1-18

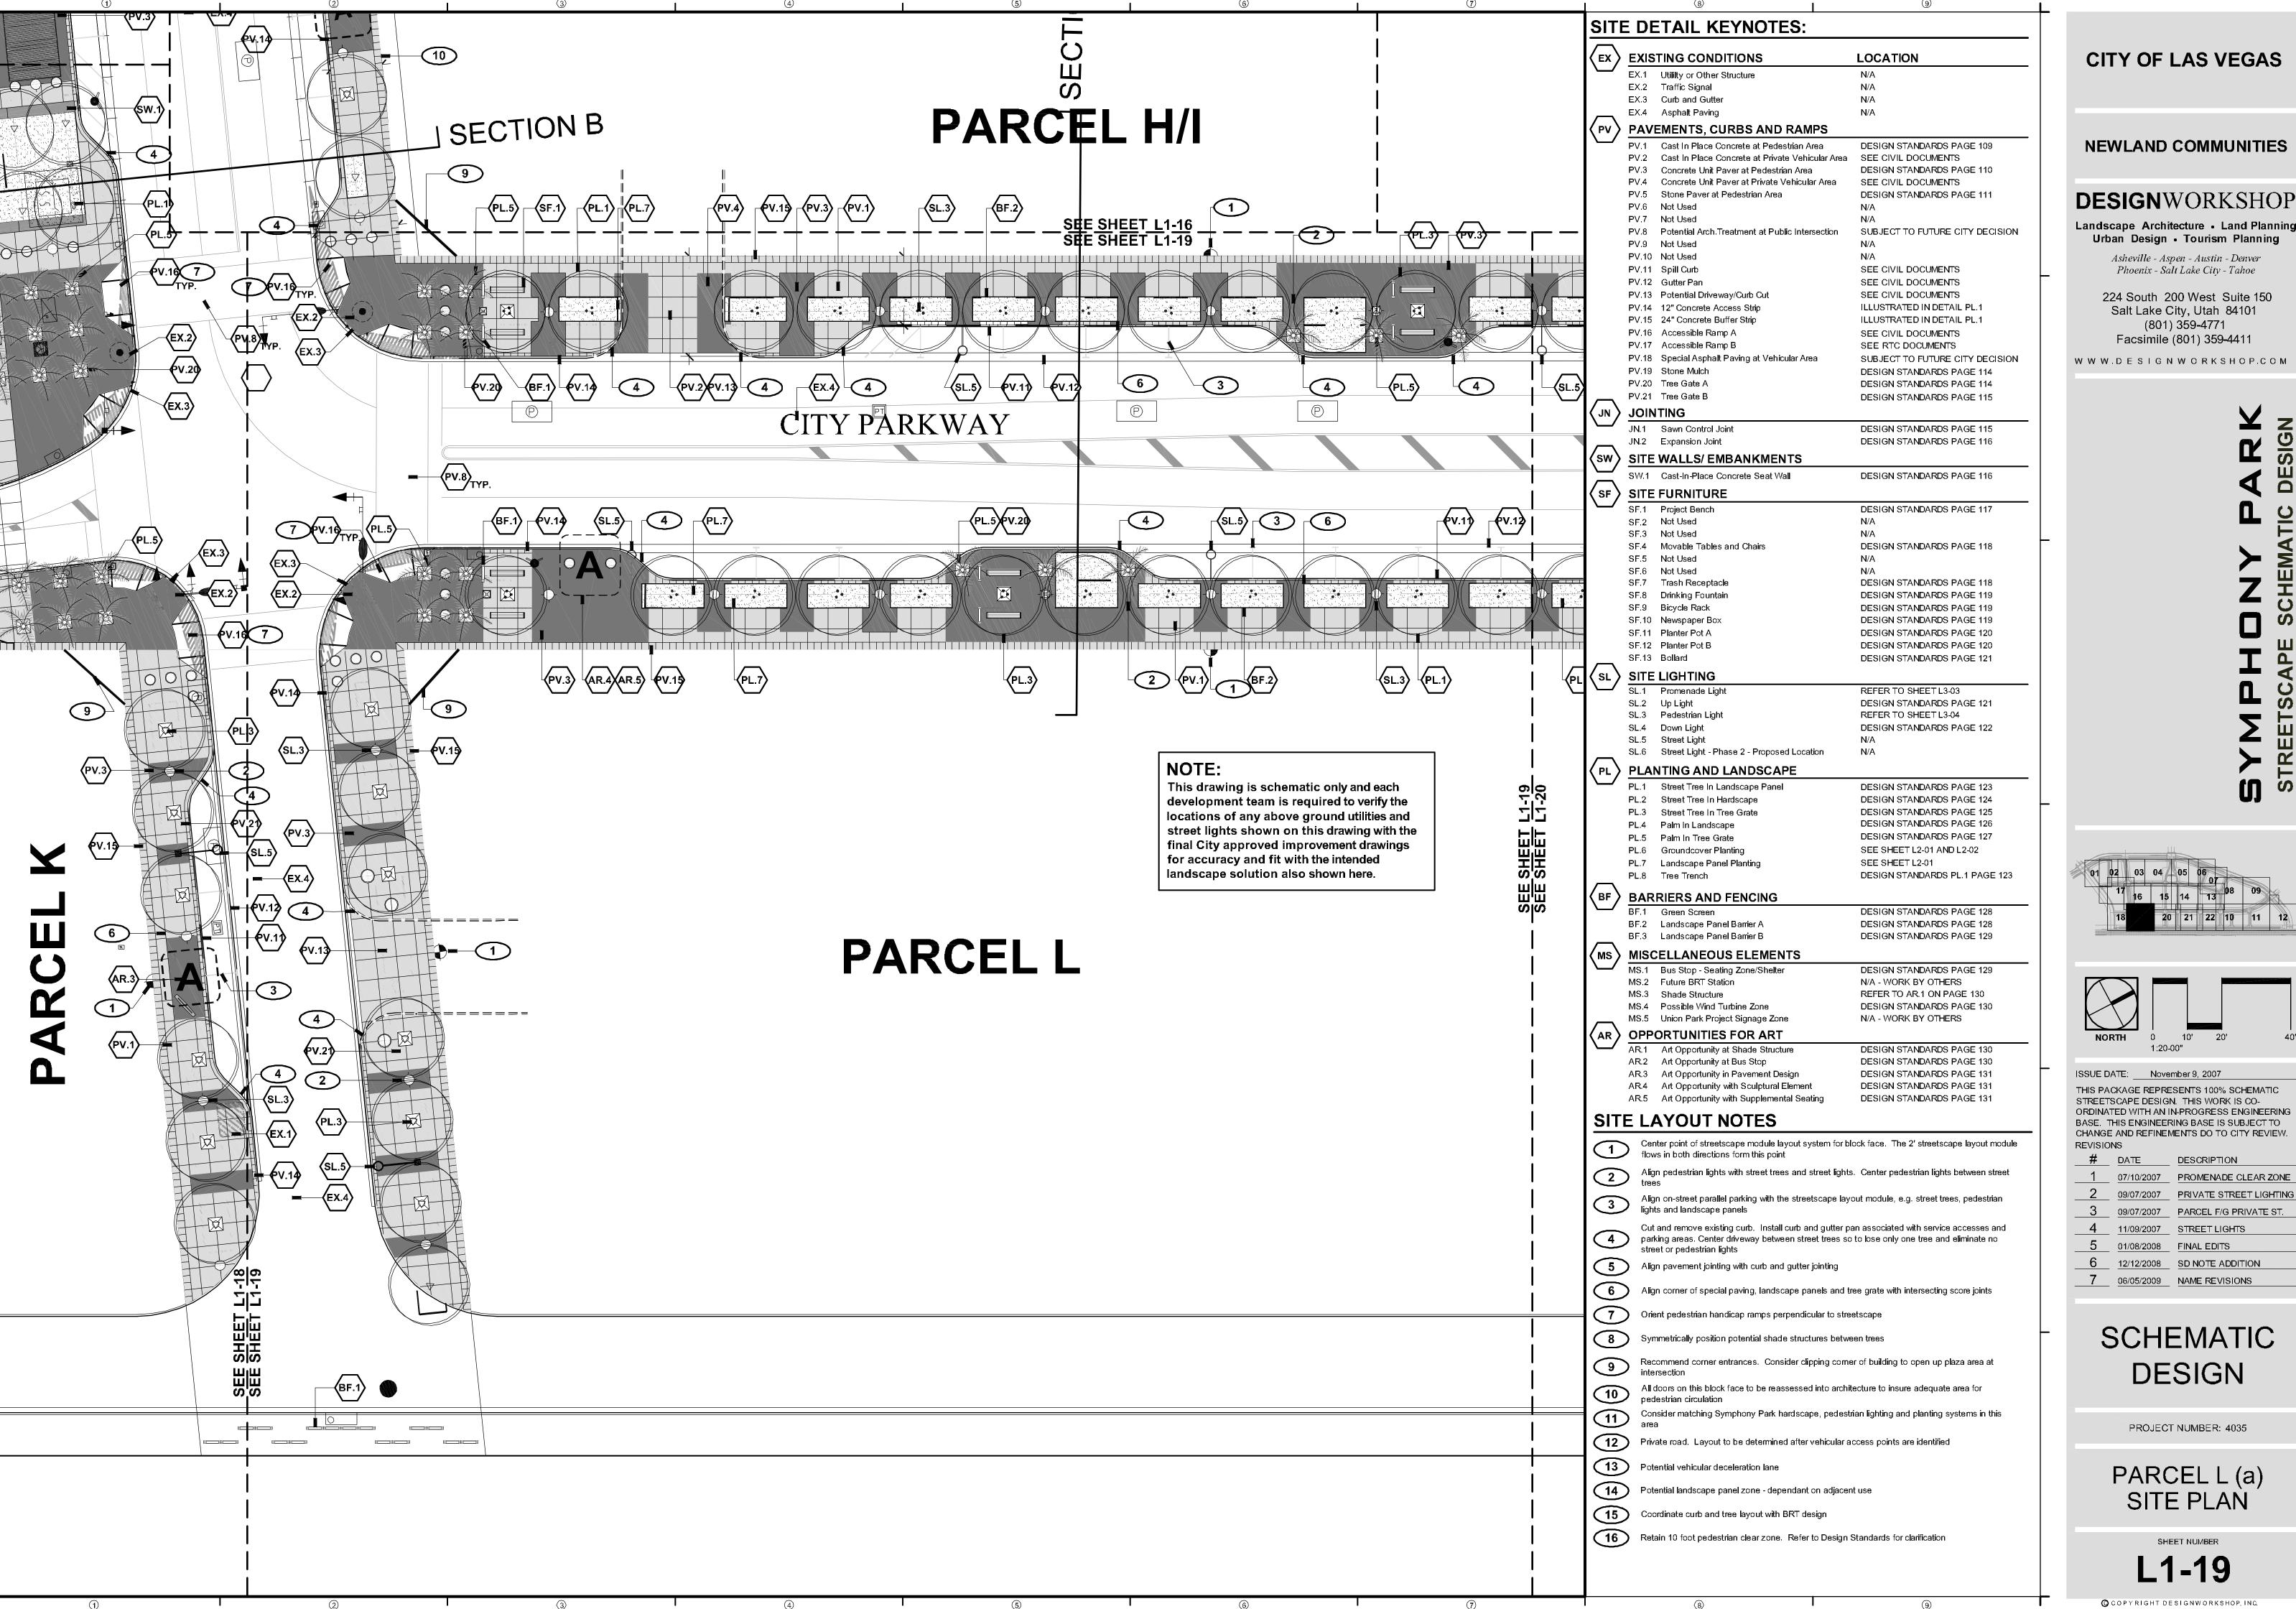

**NEWLAND COMMUNITIES** 

#### **DESIGN**WORKSHOP

Landscape Architecture • Land Planning Urban Design • Tourism Planning


> Phoenix - Salt Lake City - Tahoe 224 South 200 West Suite 150

(801) 359-4771 Facsimile (801) 359-4411

W W W.D E S I G N W O R K S H O P.C O M

SITE PLAN

OCOPYRIGHT DESIGNWORKSHOP, INC.

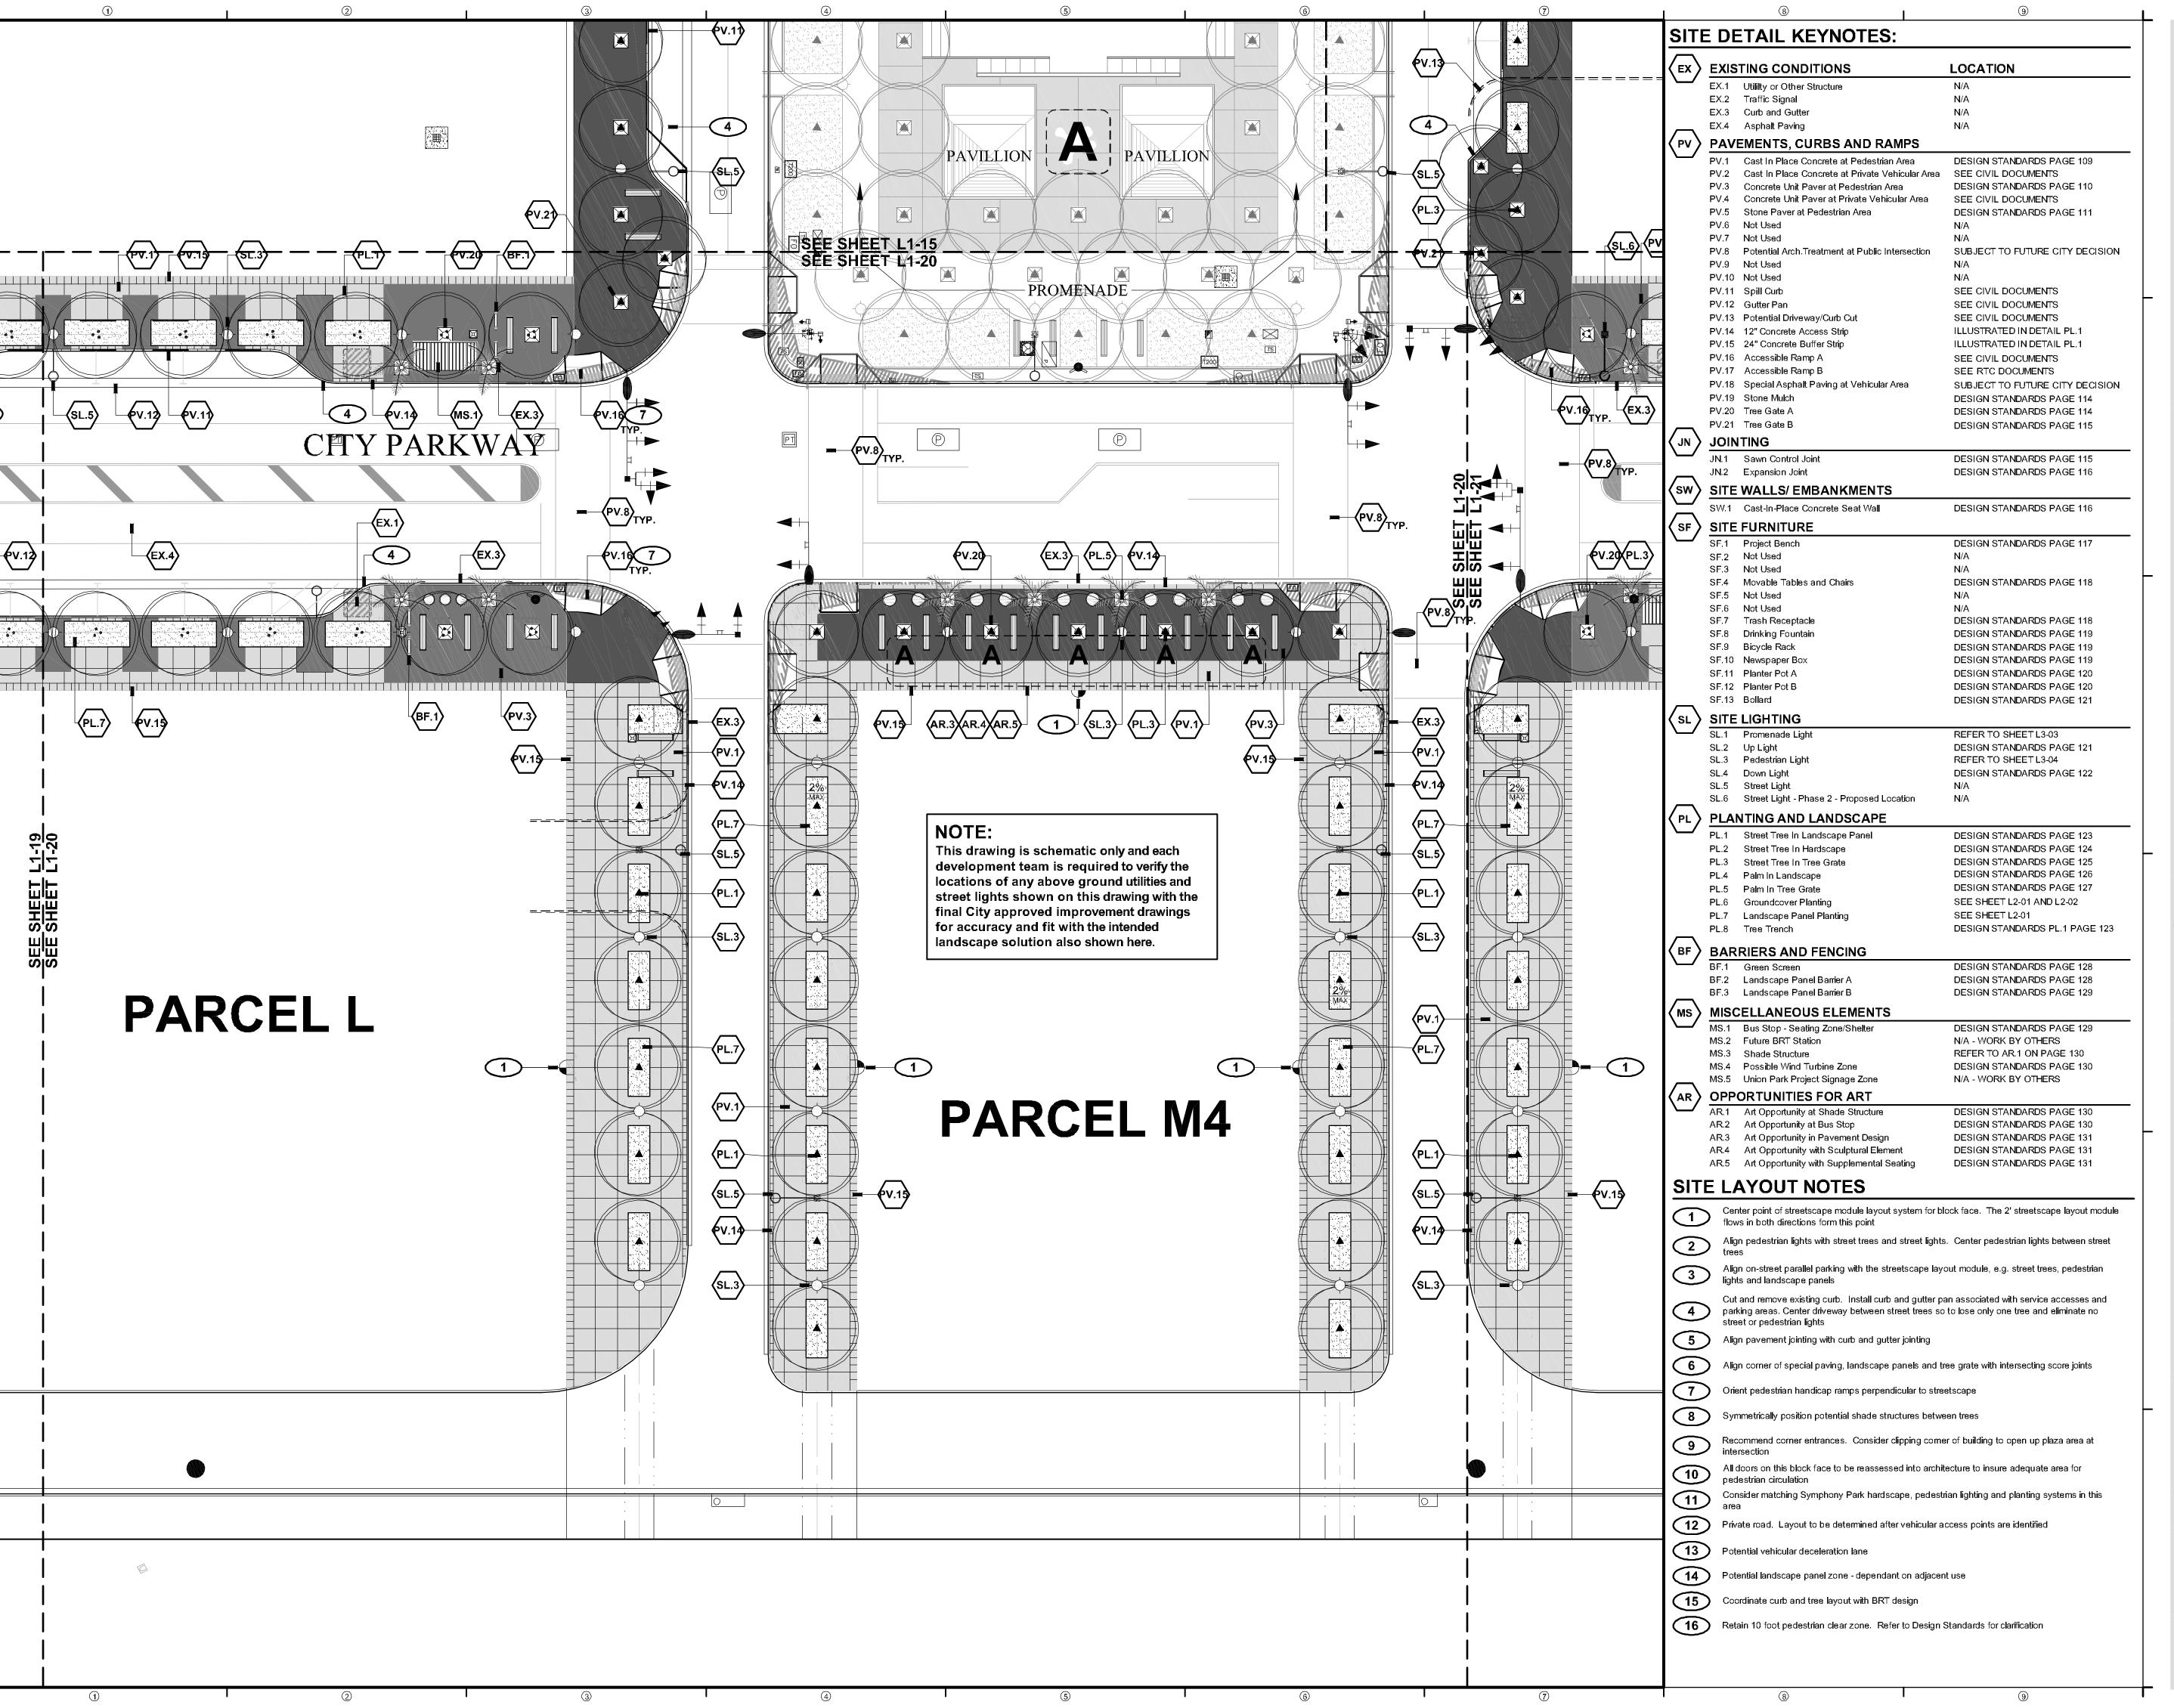

**NEWLAND COMMUNITIES** 

#### **DESIGN**WORKSHOP


Landscape Architecture • Land Planning Urban Design • Tourism Planning

Asheville - Aspen - Austin - Denver Phoenix - Salt Lake City - Tahoe

224 South 200 West Suite 150 Salt Lake City, Utah 84101 (801) 359-4771

Facsimile (801) 359-4411

W W W D E S I G N W O R K S H O P C O M

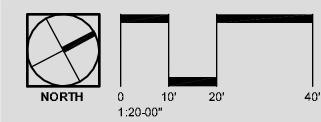

SSUE DATE: November 9, 2007 THIS PACKAGE REPRESENTS 100% SCHEMATIC BASE. THIS ENGINEERING BASE IS SUBJECT TO CHANGE AND REFINEMENTS DO TO CITY REVIEW REVISIONS

> # DATE DESCRIPTION 1 07/10/2007 PROMENADE CLEAR ZONE 09/07/2007 PRIVATE STREET LIGHTING 09/07/2007 PARCEL F/G PRIVATE ST.


4 <u>11/09/2007</u> STREET LIGHTS 5 01/08/2008 FINAL EDITS

6 12/12/2008 SD NOTE ADDITION 7 06/05/2009 NAME REVISIONS

#### SCHEMATIC DESIGN

PROJECT NUMBER: 4035

PARCEL L (b) AND M4 SITE PLAN

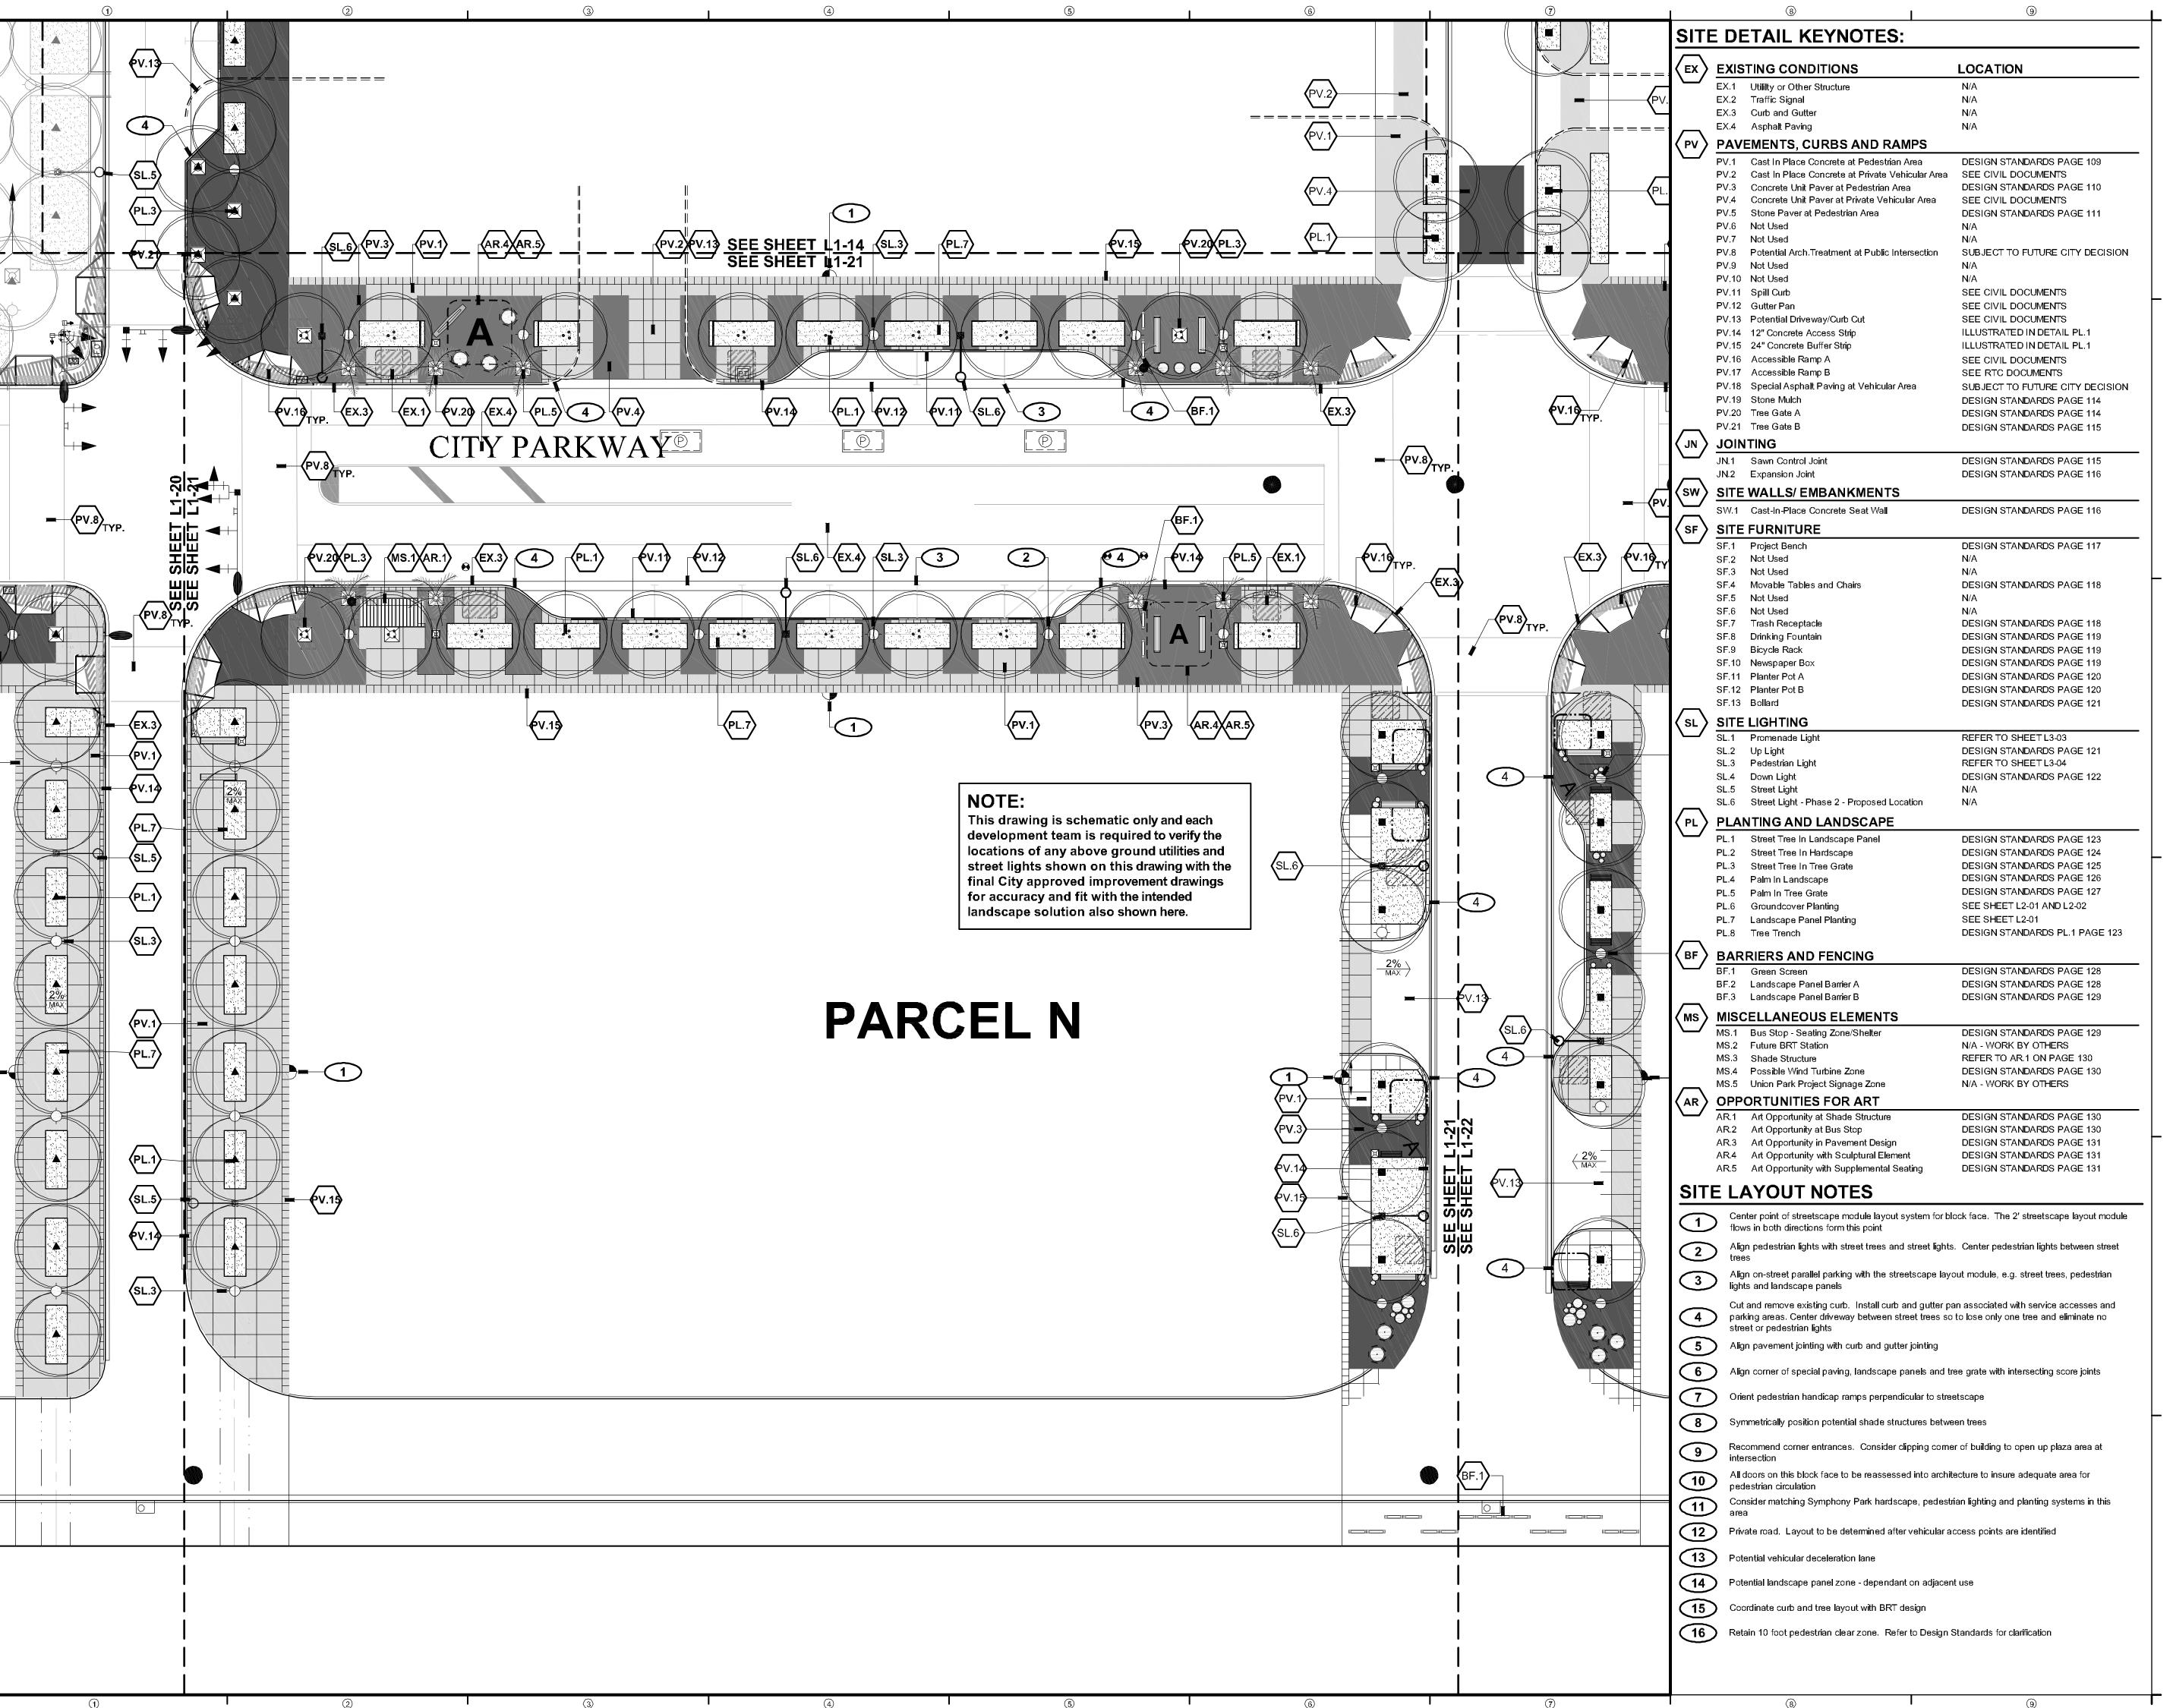

**NEWLAND COMMUNITIES** 


#### **DESIGN**WORKSHOP


Landscape Architecture • Land Planning Urban Design • Tourism Planning

> Asheville - Aspen - Austin - Denver Phoenix - Salt Lake City - Tahoe

224 South 200 West Suite 150 Salt Lake City, Utah 84101 (801) 359-4771

Facsimile (801) 359-4411 W W W.D E S I G N W O R K S H O P.C O M

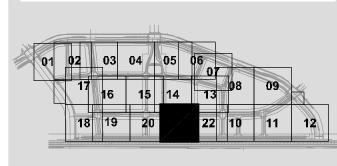

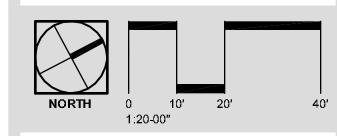

SSUE DATE: November 9, 2007 THIS PACKAGE REPRESENTS 100% SCHEMATIC STREETSCAPE DESIGN. THIS WORK IS CO-ORDINATED WITH AN IN-PROGRESS ENGINEERING BASE. THIS ENGINEERING BASE IS SUBJECT TO CHANGE AND REFINEMENTS DO TO CITY REVIEW REVISIONS

1 07/10/2007 PROMENADE CLEAR ZONE 09/07/2007 PRIVATE STREET LIGHTING 09/07/2007 PARCEL F/G PRIVATE ST. 11/09/2007 STREET LIGHTS

5 01/08/2008 FINAL EDITS

# DATE DESCRIPTION

6 12/12/2008 SD NOTE ADDITION 7 06/05/2009 NAME REVISIONS


### SCHEMATIC DESIGN

PROJECT NUMBER: 4035

PARCEL N SITE PLAN

SHEET NUMBER

OCOPYRIGHT DESIGNWORKSHOP, INC.

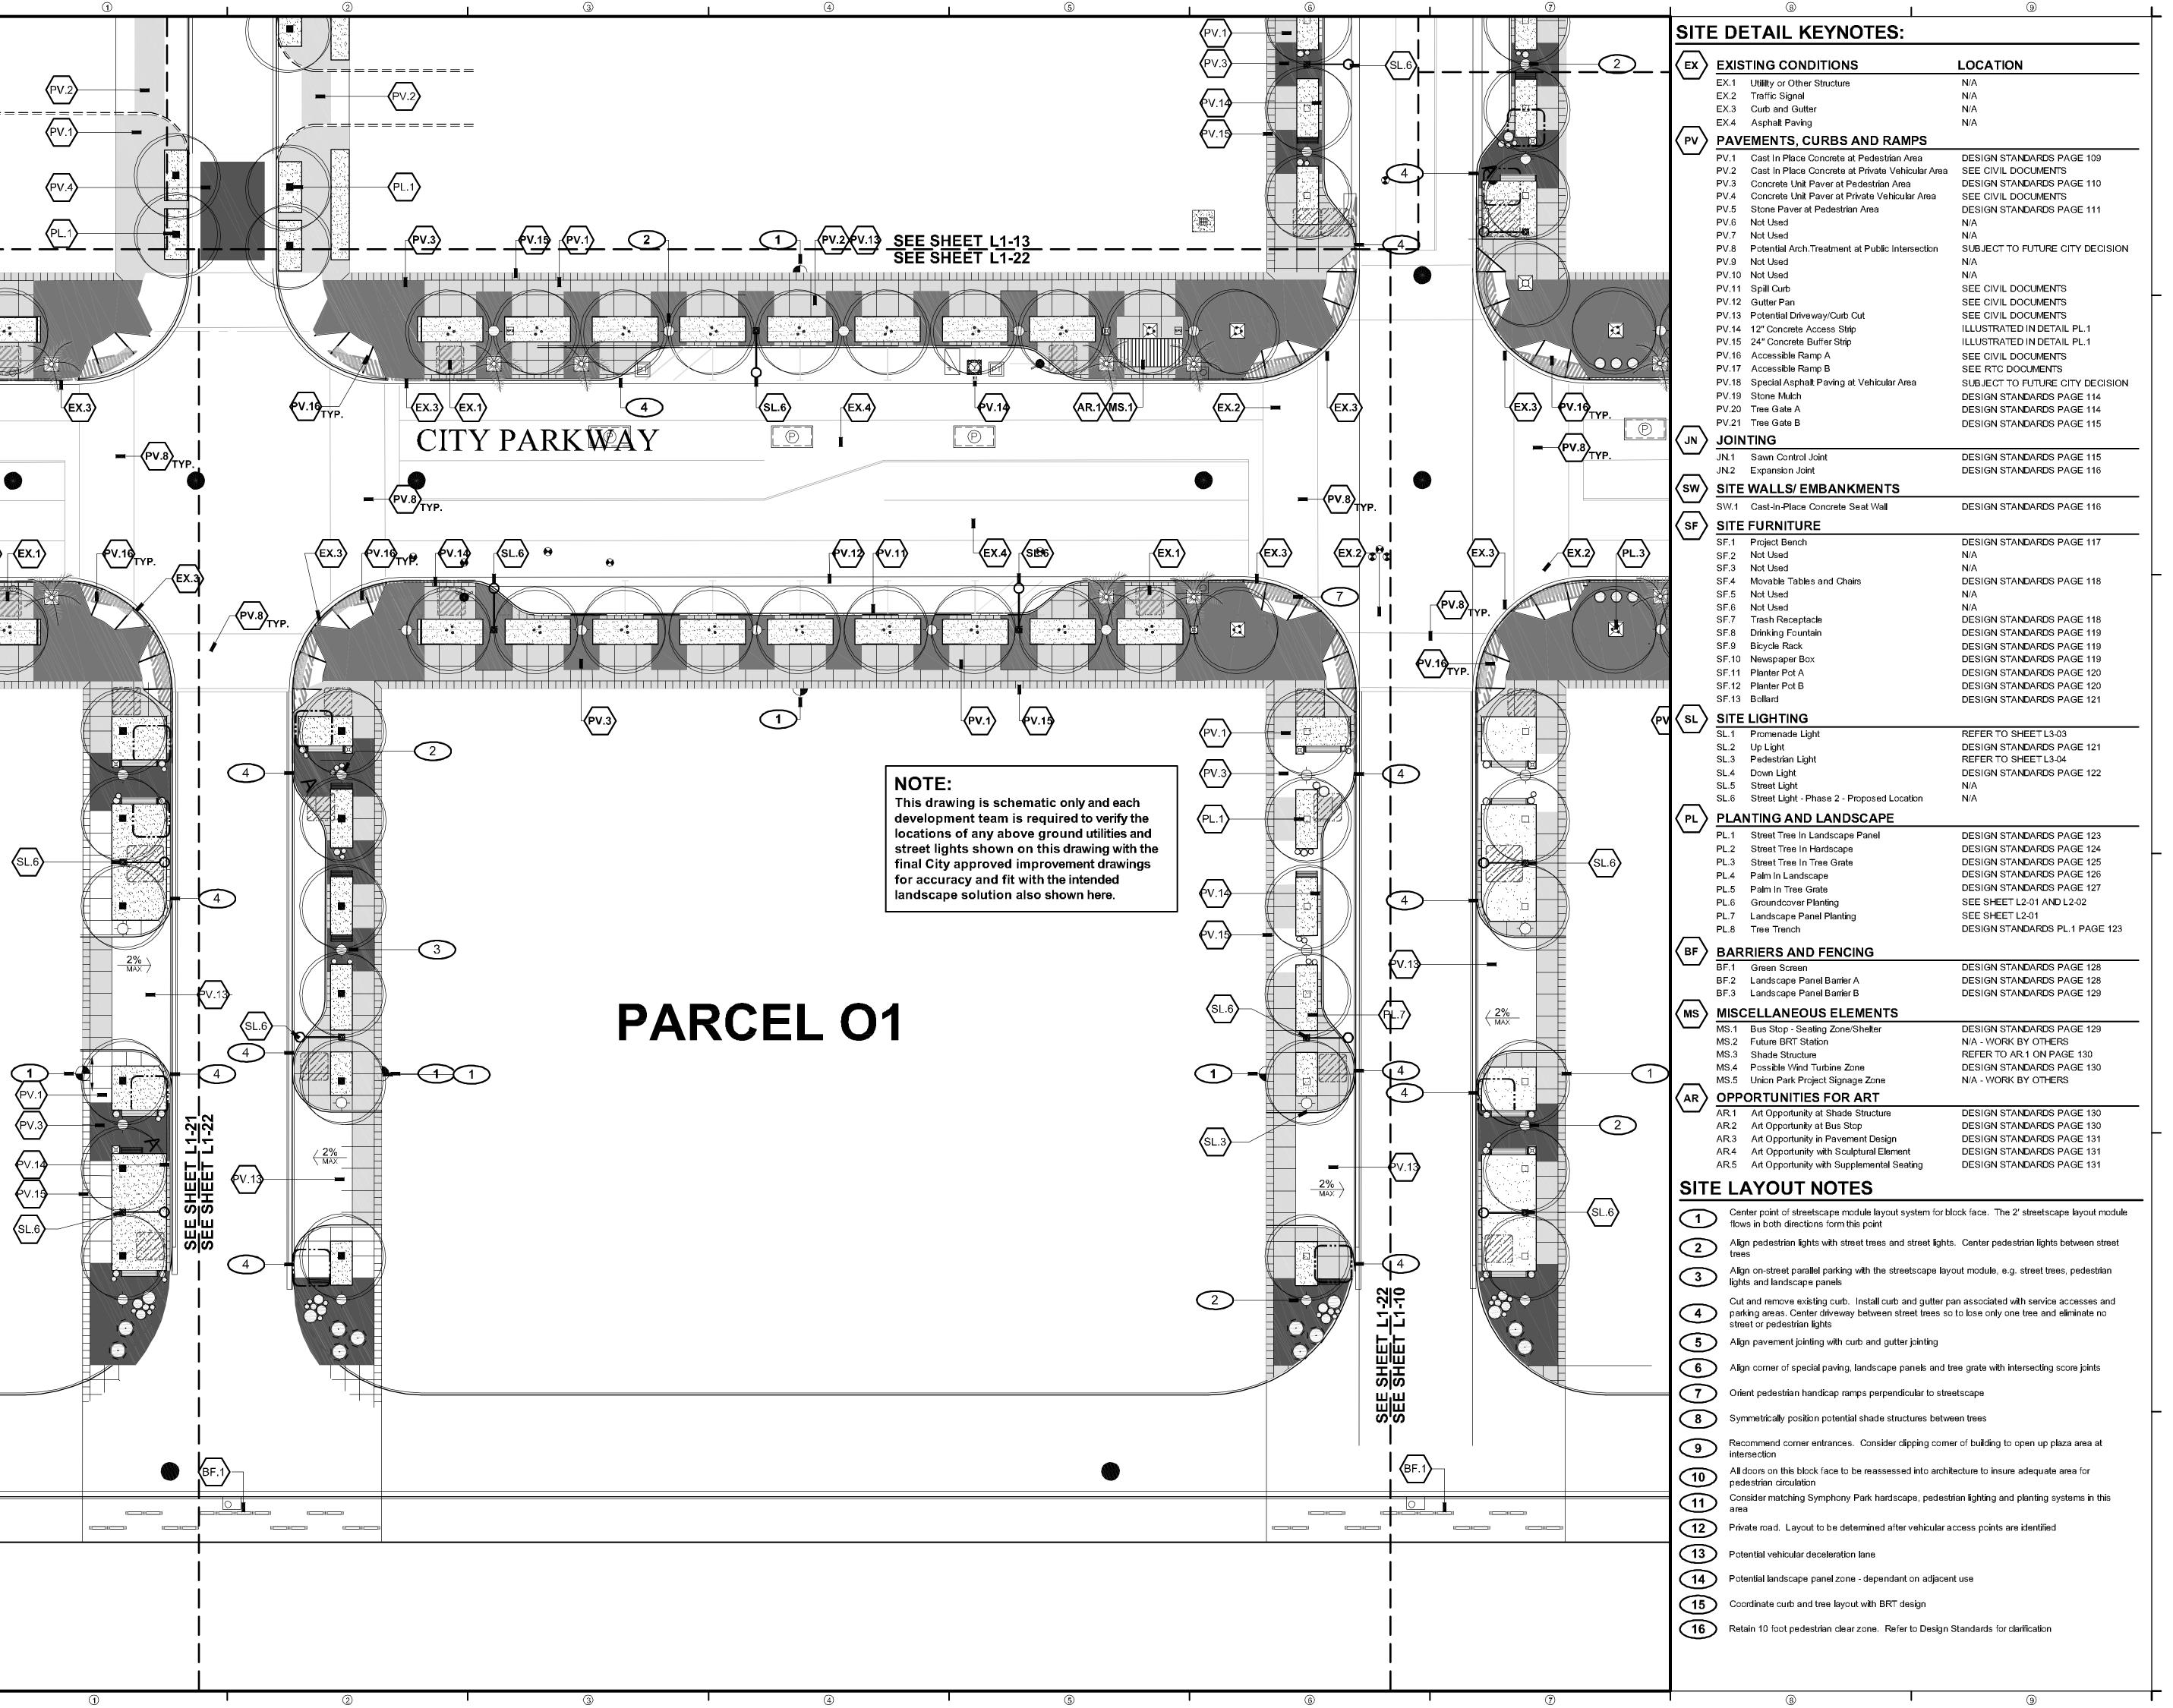

**NEWLAND COMMUNITIES** 

#### **DESIGN**WORKSHOP

Landscape Architecture • Land Planning
Urban Design • Tourism Planning

Asheville - Aspen - Austin - Denver Phoenix - Salt Lake City - Tahoe 224 South 200 West Suite 150

Salt Lake City, Utah 84101 (801) 359-4771 Facsimile (801) 359-4411

W W W.D E S I G N W O R K S H O P.C O M

**V** -

SITE PLAN
SHEET NUMBER

SSUE DATE: November 9, 2007

REVISIONS

THIS PACKAGE REPRESENTS 100% SCHEMATIC

BASE. THIS ENGINEERING BASE IS SUBJECT TO CHANGE AND REFINEMENTS DO TO CITY REVIEW

1 07/10/2007 PROMENADE CLEAR ZONE

11/09/2007 STREET LIGHTS

6 12/12/2008 SD NOTE ADDITION

SCHEMATIC

DESIGN

PROJECT NUMBER: 4035

PARCEL 01

7 06/05/2009 NAME REVISIONS

09/07/2007 PRIVATE STREET LIGHTING

09/07/2007 PARCEL F/G PRIVATE ST.

STREETSCAPE DESIGN. THIS WORK IS CO-ORDINATED WITH AN IN-PROGRESS ENGINEERING

# DATE DESCRIPTION

5 01/08/2008 FINAL EDITS

OCOPYRIGHT DESIGNWORKSHOP, INC.

#### **NEWLAND COMMUNITIES**

#### **DESIGN**WORKSHOP

Landscape Architecture • Land Planning
Urban Design • Tourism Planning

Asheville - Aspen - Austin - Denver Phoenix - Salt Lake City - Tahoe

224 South 200 West Suite 150 Salt Lake City, Utah 84101 (801) 359-4771

W W W.D E S I G N W O R K S H O P.C O M

DE

ISSUE DATE: November 9, 2007 THIS PACKAGE REPRESENTS 100% SCHEMATIC STREETSCAPE DESIGN. THIS WORK IS CO-ORDINATED WITH AN IN-PROGRESS ENGINEERING BASE. THIS ENGINEERING BASE IS SUBJECT TO CHANGE AND REFINEMENTS DO TO CITY REVIEW. REVISIONS

2 09/07/2007 PRIVATE STREET LIGHTING 3 09/07/2007 PARCEL F/G PRIVATE ST.

4 11/09/2007 STREET LIGHTS 5 <u>01/08/2008</u> FINAL EDITS

6 12/12/2008 SD NOTE ADDITION 7 06/05/2009 NAME REVISIONS

SCHEMATIC


DESIGN

PROJECT NUMBER: 4035

PLANTING MATRIX

SHEET NUMBER

L2-01

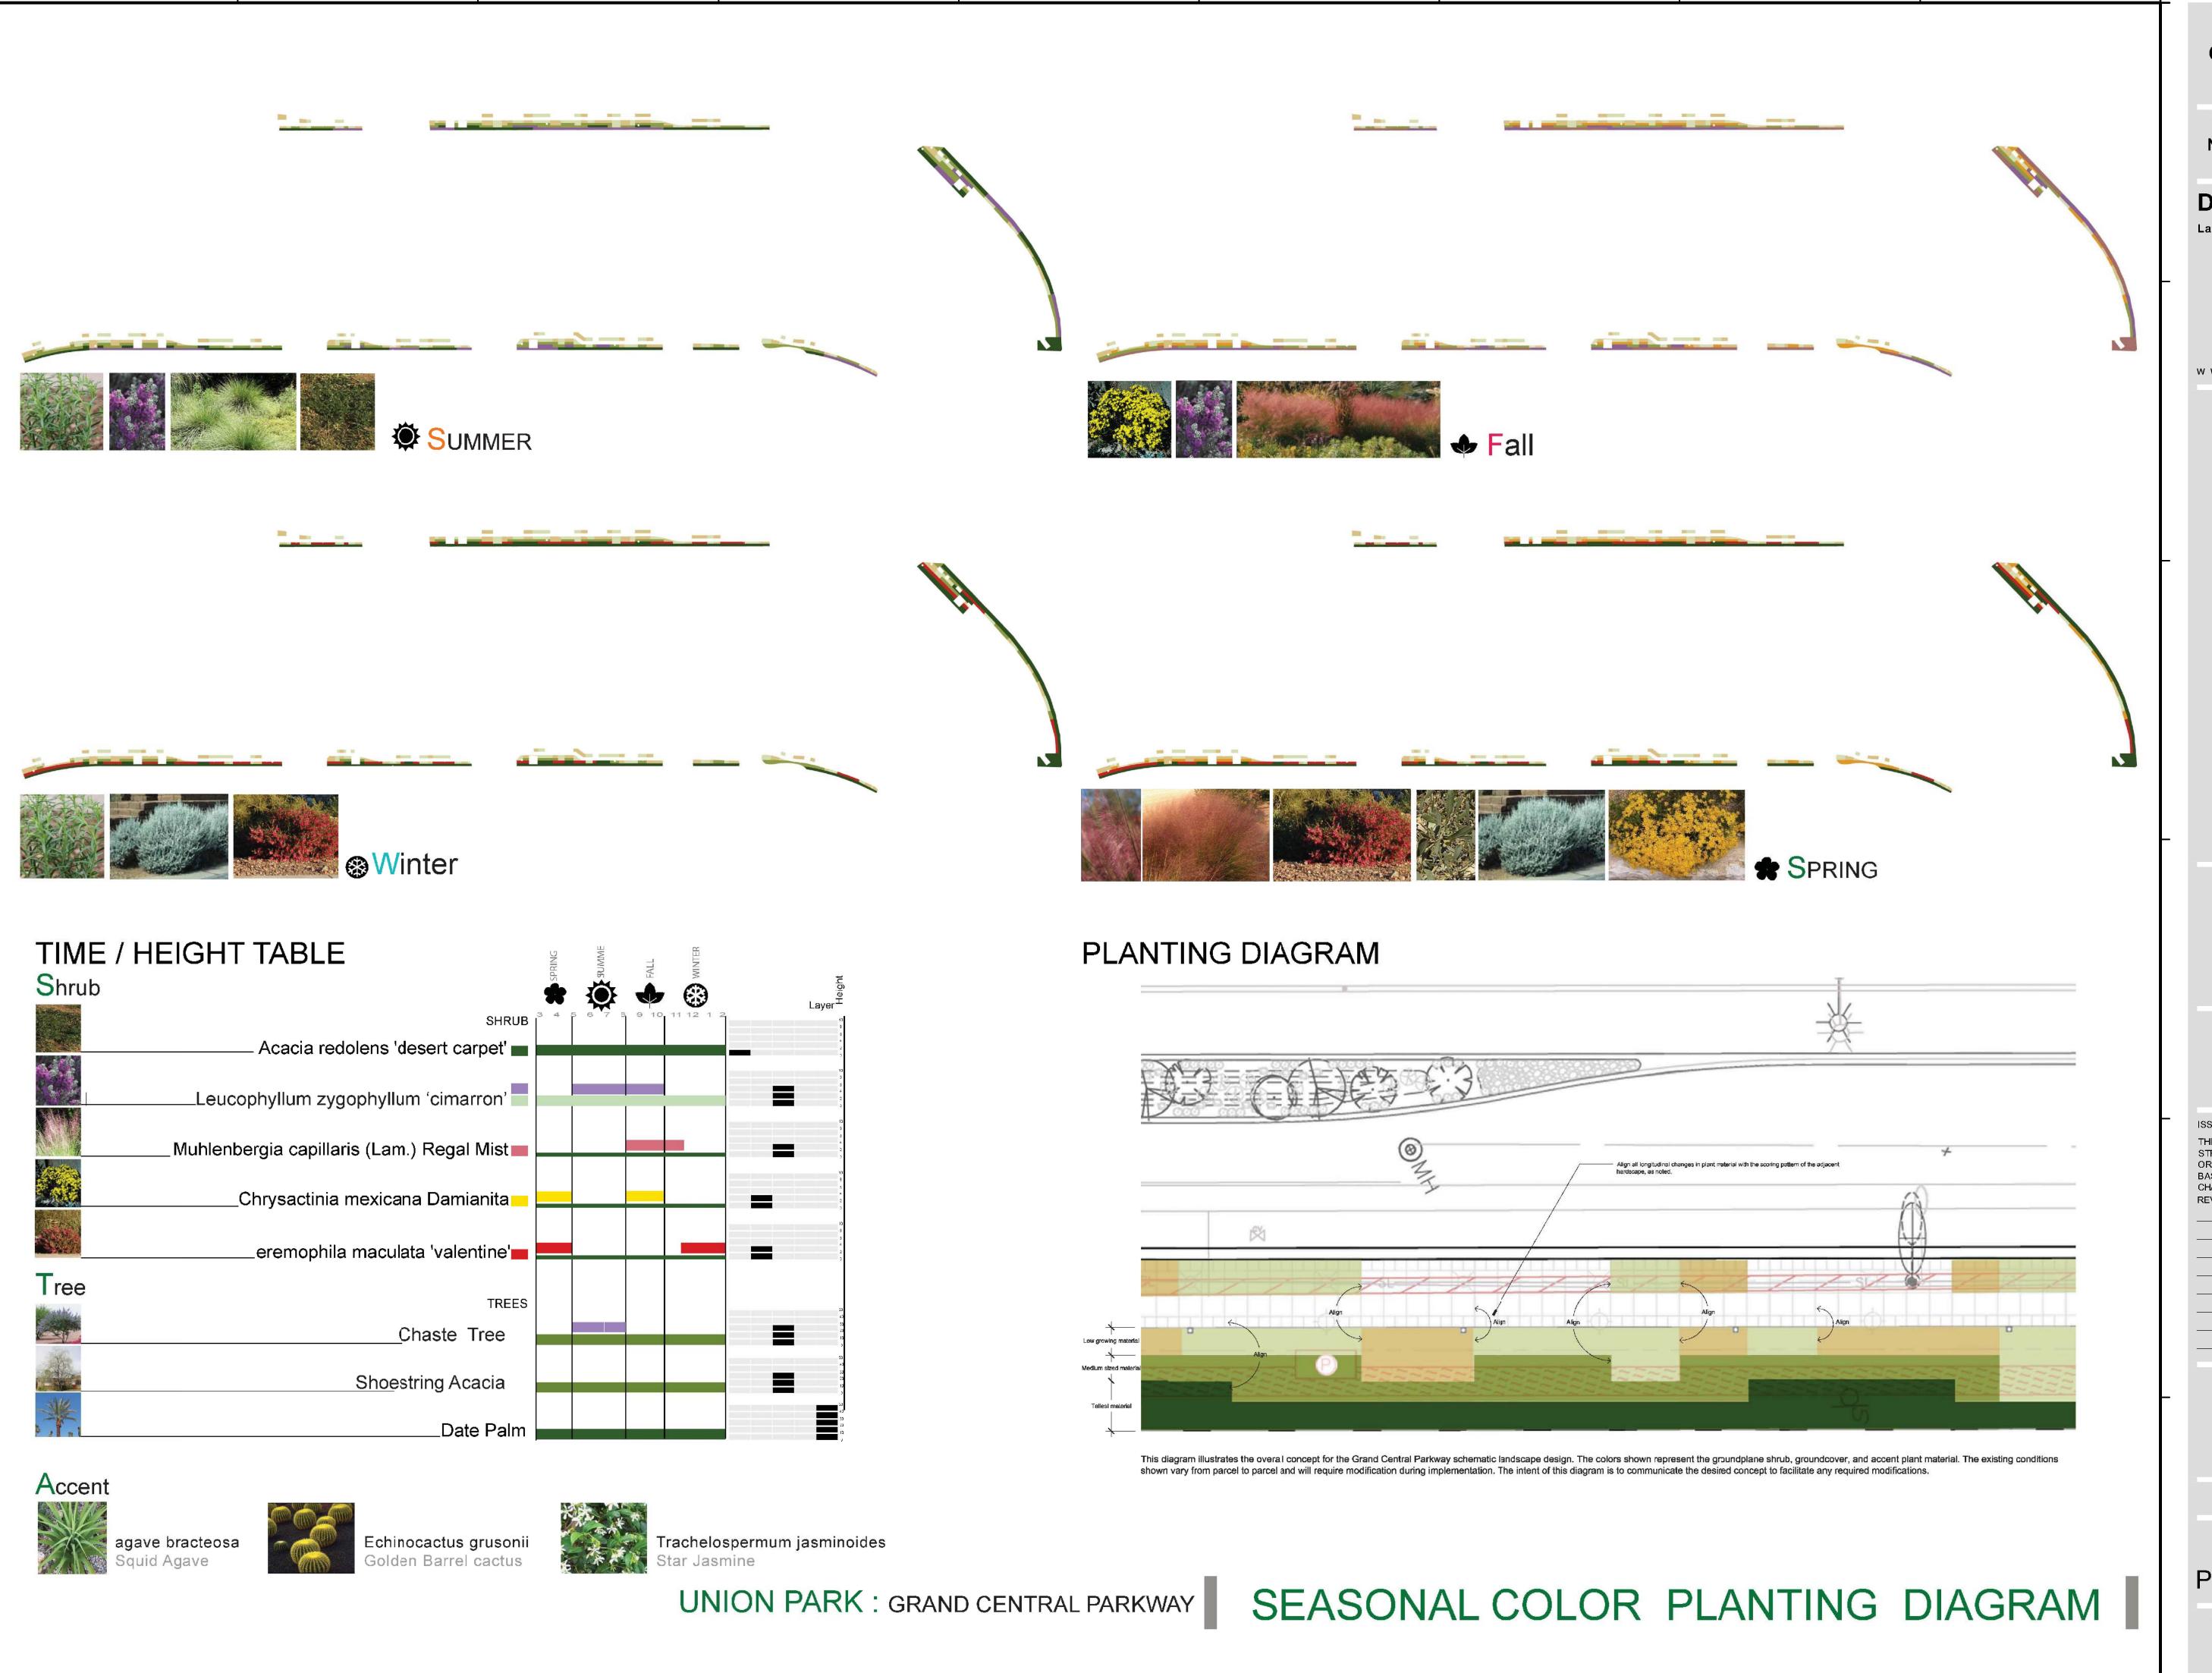

NEWLAND COMMUNITIES

**DESIGN**WORKSHOP

Landscape Architecture • Land Planning
Urban Design • Tourism Planning

-Asheville - Aspen - Austin - Denver Phoenix - Salt Lake City - Tahoe

224 South 200 West Suite 150 Salt Lake City, Utah 84101 (801) 359-4771

Facsimile (801) 359-4411

W W W.D E S I G N W O R K S H O P.C O M

PARK

STREETSCAPE SCHEMATIC DES

ISSUE DATE: November 9, 2007

THIS PACKAGE REPRESENTS 100% SCHEMATIC STREETSCAPE DESIGN. THIS WORK IS CO-ORDINATED WITH AN IN-PROGRESS ENGINEERING BASE. THIS ENGINEERING BASE IS SUBJECT TO CHANGE AND REFINEMENTS DO TO CITY REVIEW. REVISIONS

 #
 DATE
 DESCRIPTION

 1
 07/10/2007
 PROMENADE CLEAR ZONE

 2
 09/07/2007
 PRIVATE STREET LIGHTING

 3
 09/07/2007
 PARCEL F/G PRIVATE ST.

 4
 14/09/2007
 STREET LIGHTS

4 11/09/2007 STREET LIGHTS
5 01/08/2008 FINAL EDITS

6 12/12/2008 SD NOTE ADDITION
7 06/05/2009 NAME REVISIONS


SCHEMATIC DESIGN

PROJECT NUMBER: 4035

GCP PLANTING DIAGRAM

SHEET NUMBER

L2-02

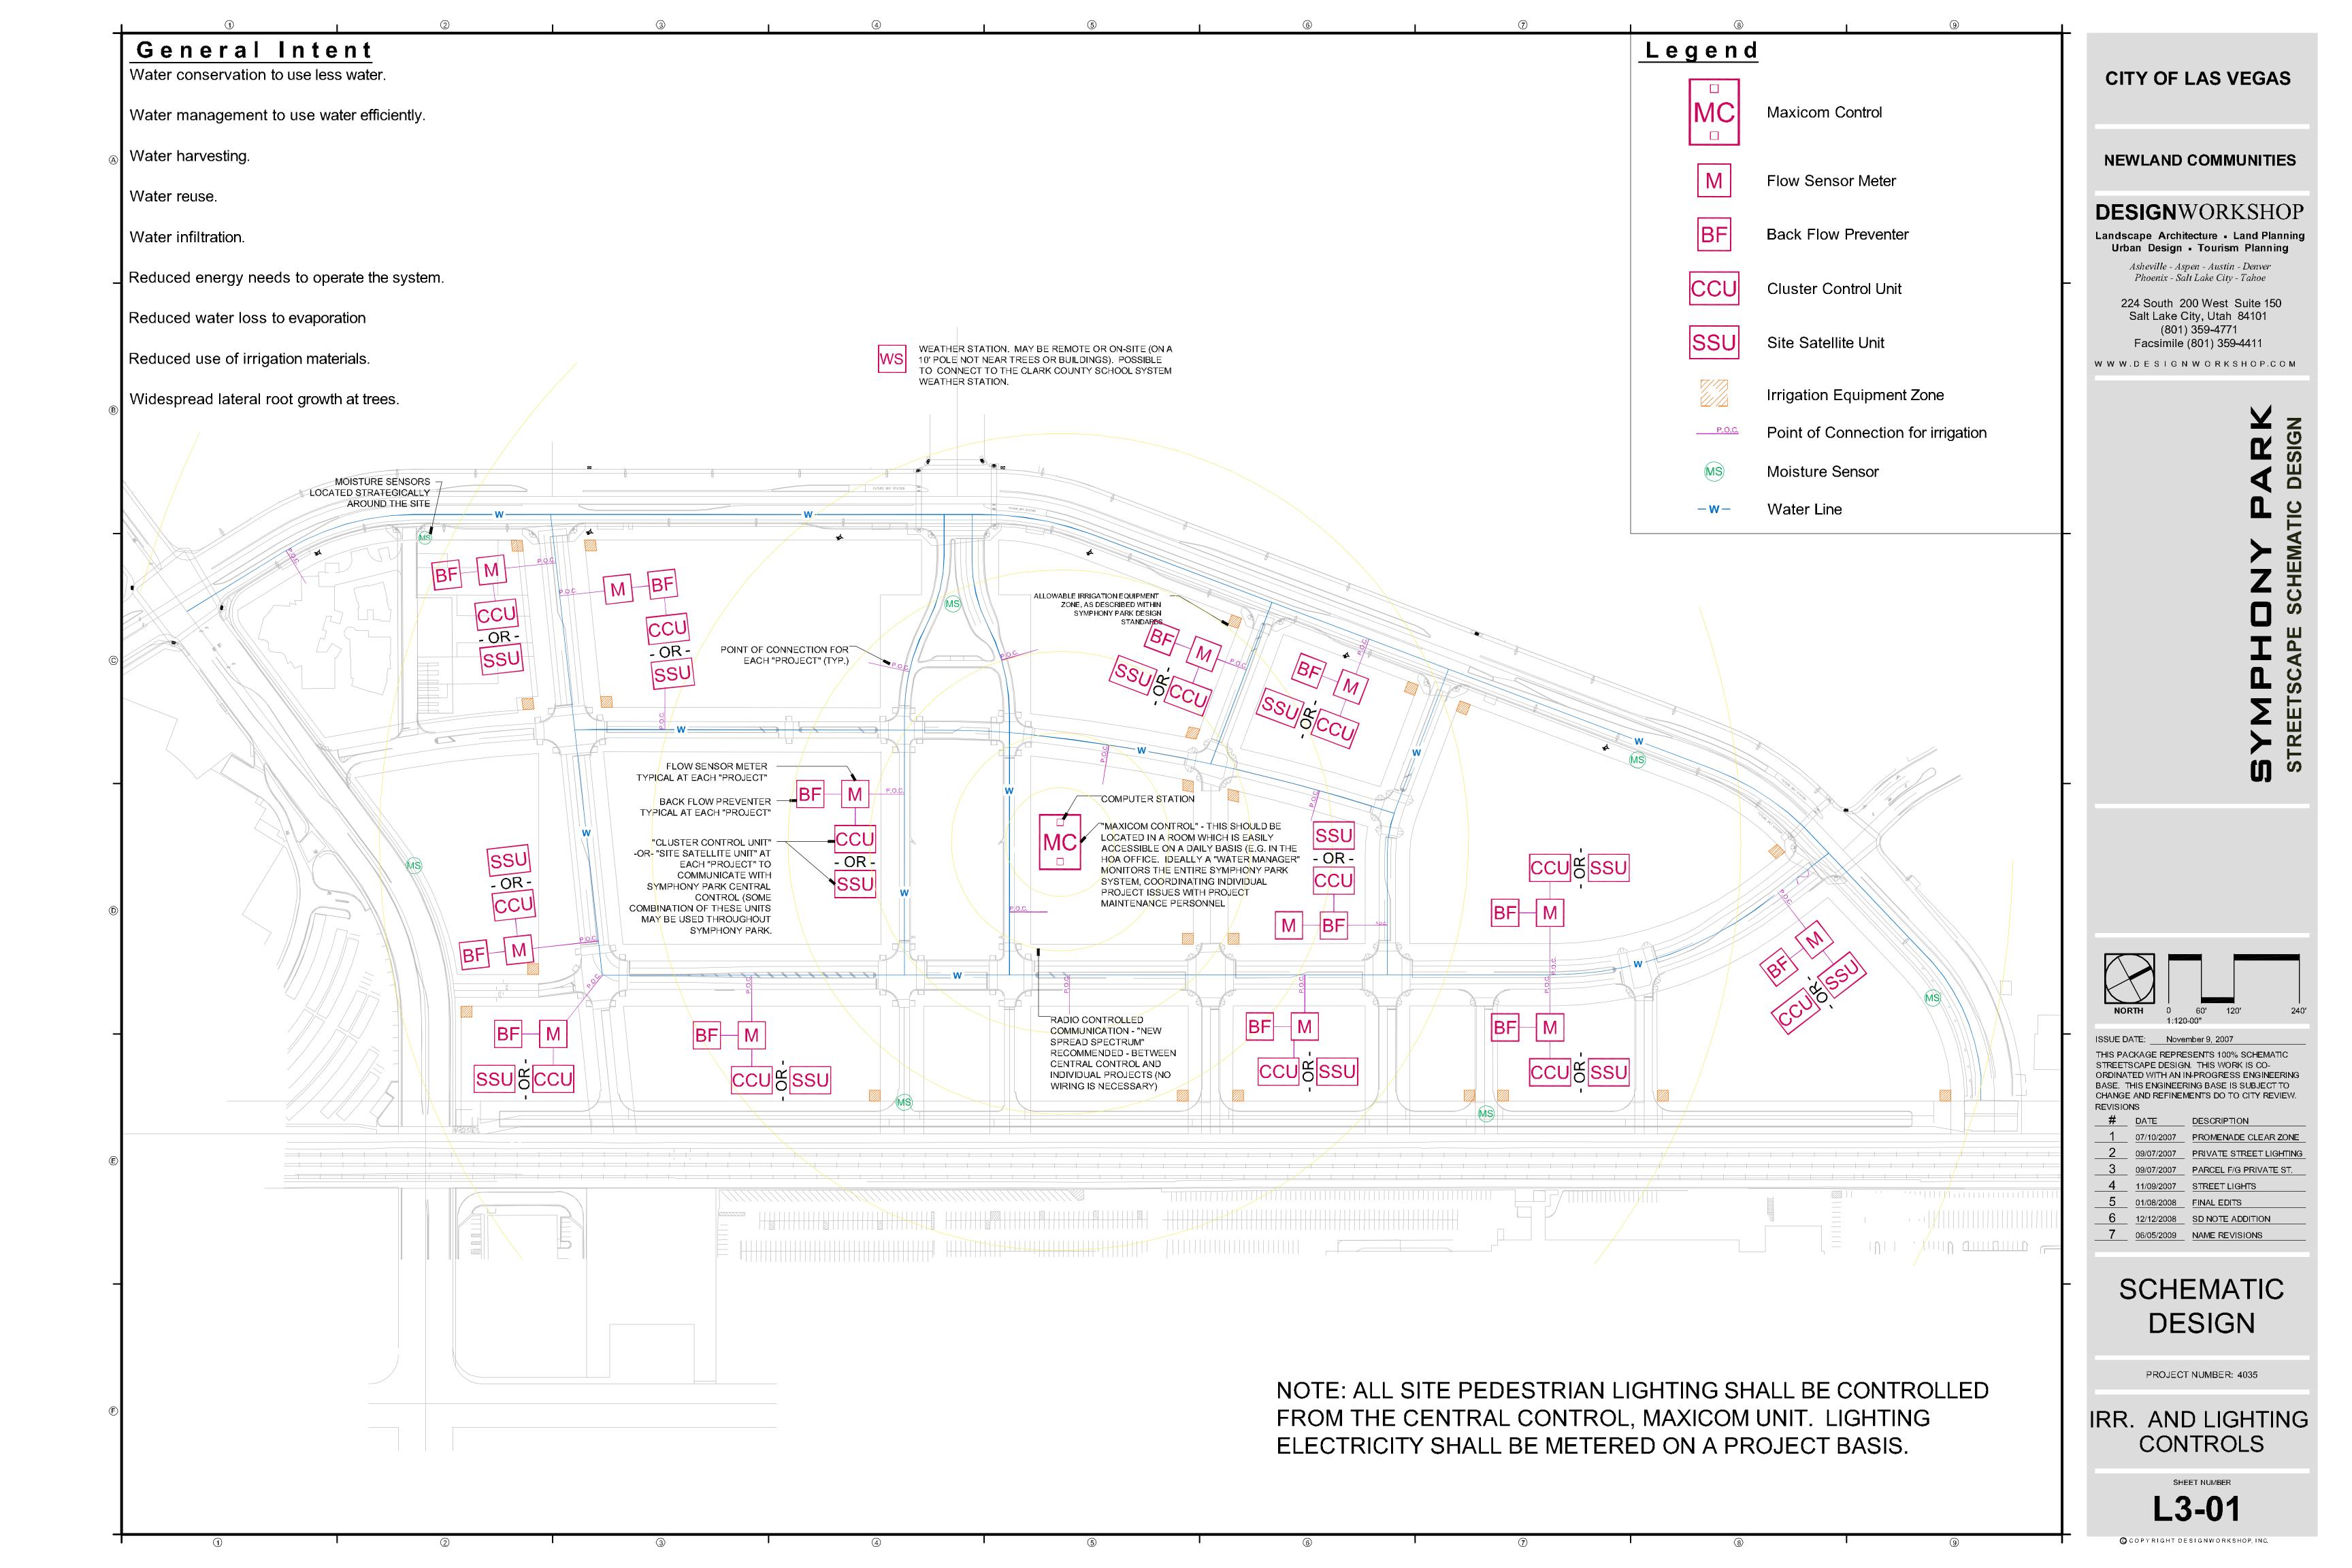

#### **General Intent of Irrigation**

#### **Efficiency**

All streetscape shall utilize water conserving irrigation products as defined with the Symphony Park Design Standards;

#### **Adaptability**

All irrigation systems must provide for the potential for grey water use.

#### Continuity

The site wide master controller is to manage all streetscape lighting and irrigation throughout the entire Union Park project. All irrigation will be orchestrated from this main controller to bring a unified management approach to the entire Symphony Park landscape.

#### **Assumptions**

#### Irrigation Designer

Individual Developers will hire a certified irrigation designer to design the irrigation plans for the Design Development and Consruction Documentation phases of the project

#### Irrigation Requirements

The owner of each project shall supply and install ESP site satellite controllers, manufactured by Rainbird (r). The ESP site satellite controllers shall be programmed for control of irrigation valves, pedestrian lighting, and landscape lighting. The ESP site satellites shall be controlled with maxicom2(r) central control system software, via two-wire telephone modem or approved equivalent.

The owner of each project shall furnish, install, and maintain power and either a two-wire telephone input with active telephone service or approved equivalent for each ESP site satellite installed.


The owner of each project shall install and appropriately incorporate 24 volt relay switches for control of the pedestrian and landscape lighting.

ESP site satellites shall be installed and programmed per Rainbird (r) specifications and recommendations. The maxicom2(r) system shall be maintained and operated by the Union Park HOA. All station details must be provided to the Symphony Park association. The details mush include flow rate, plant material type, emission devices, and station number. This information will be used to program the maxicom2(r) software.

The owner of each project shall install at least every 100 feet, on each block face, a vandal proof hose bib for streetscape maintenance.

The owner of each project, where applicable, shall install a weatherproof electrical outlet at the base of each palm.

Along promenade, the owner of each project shall install a weatherproof electrical outlet at the base of each tree.

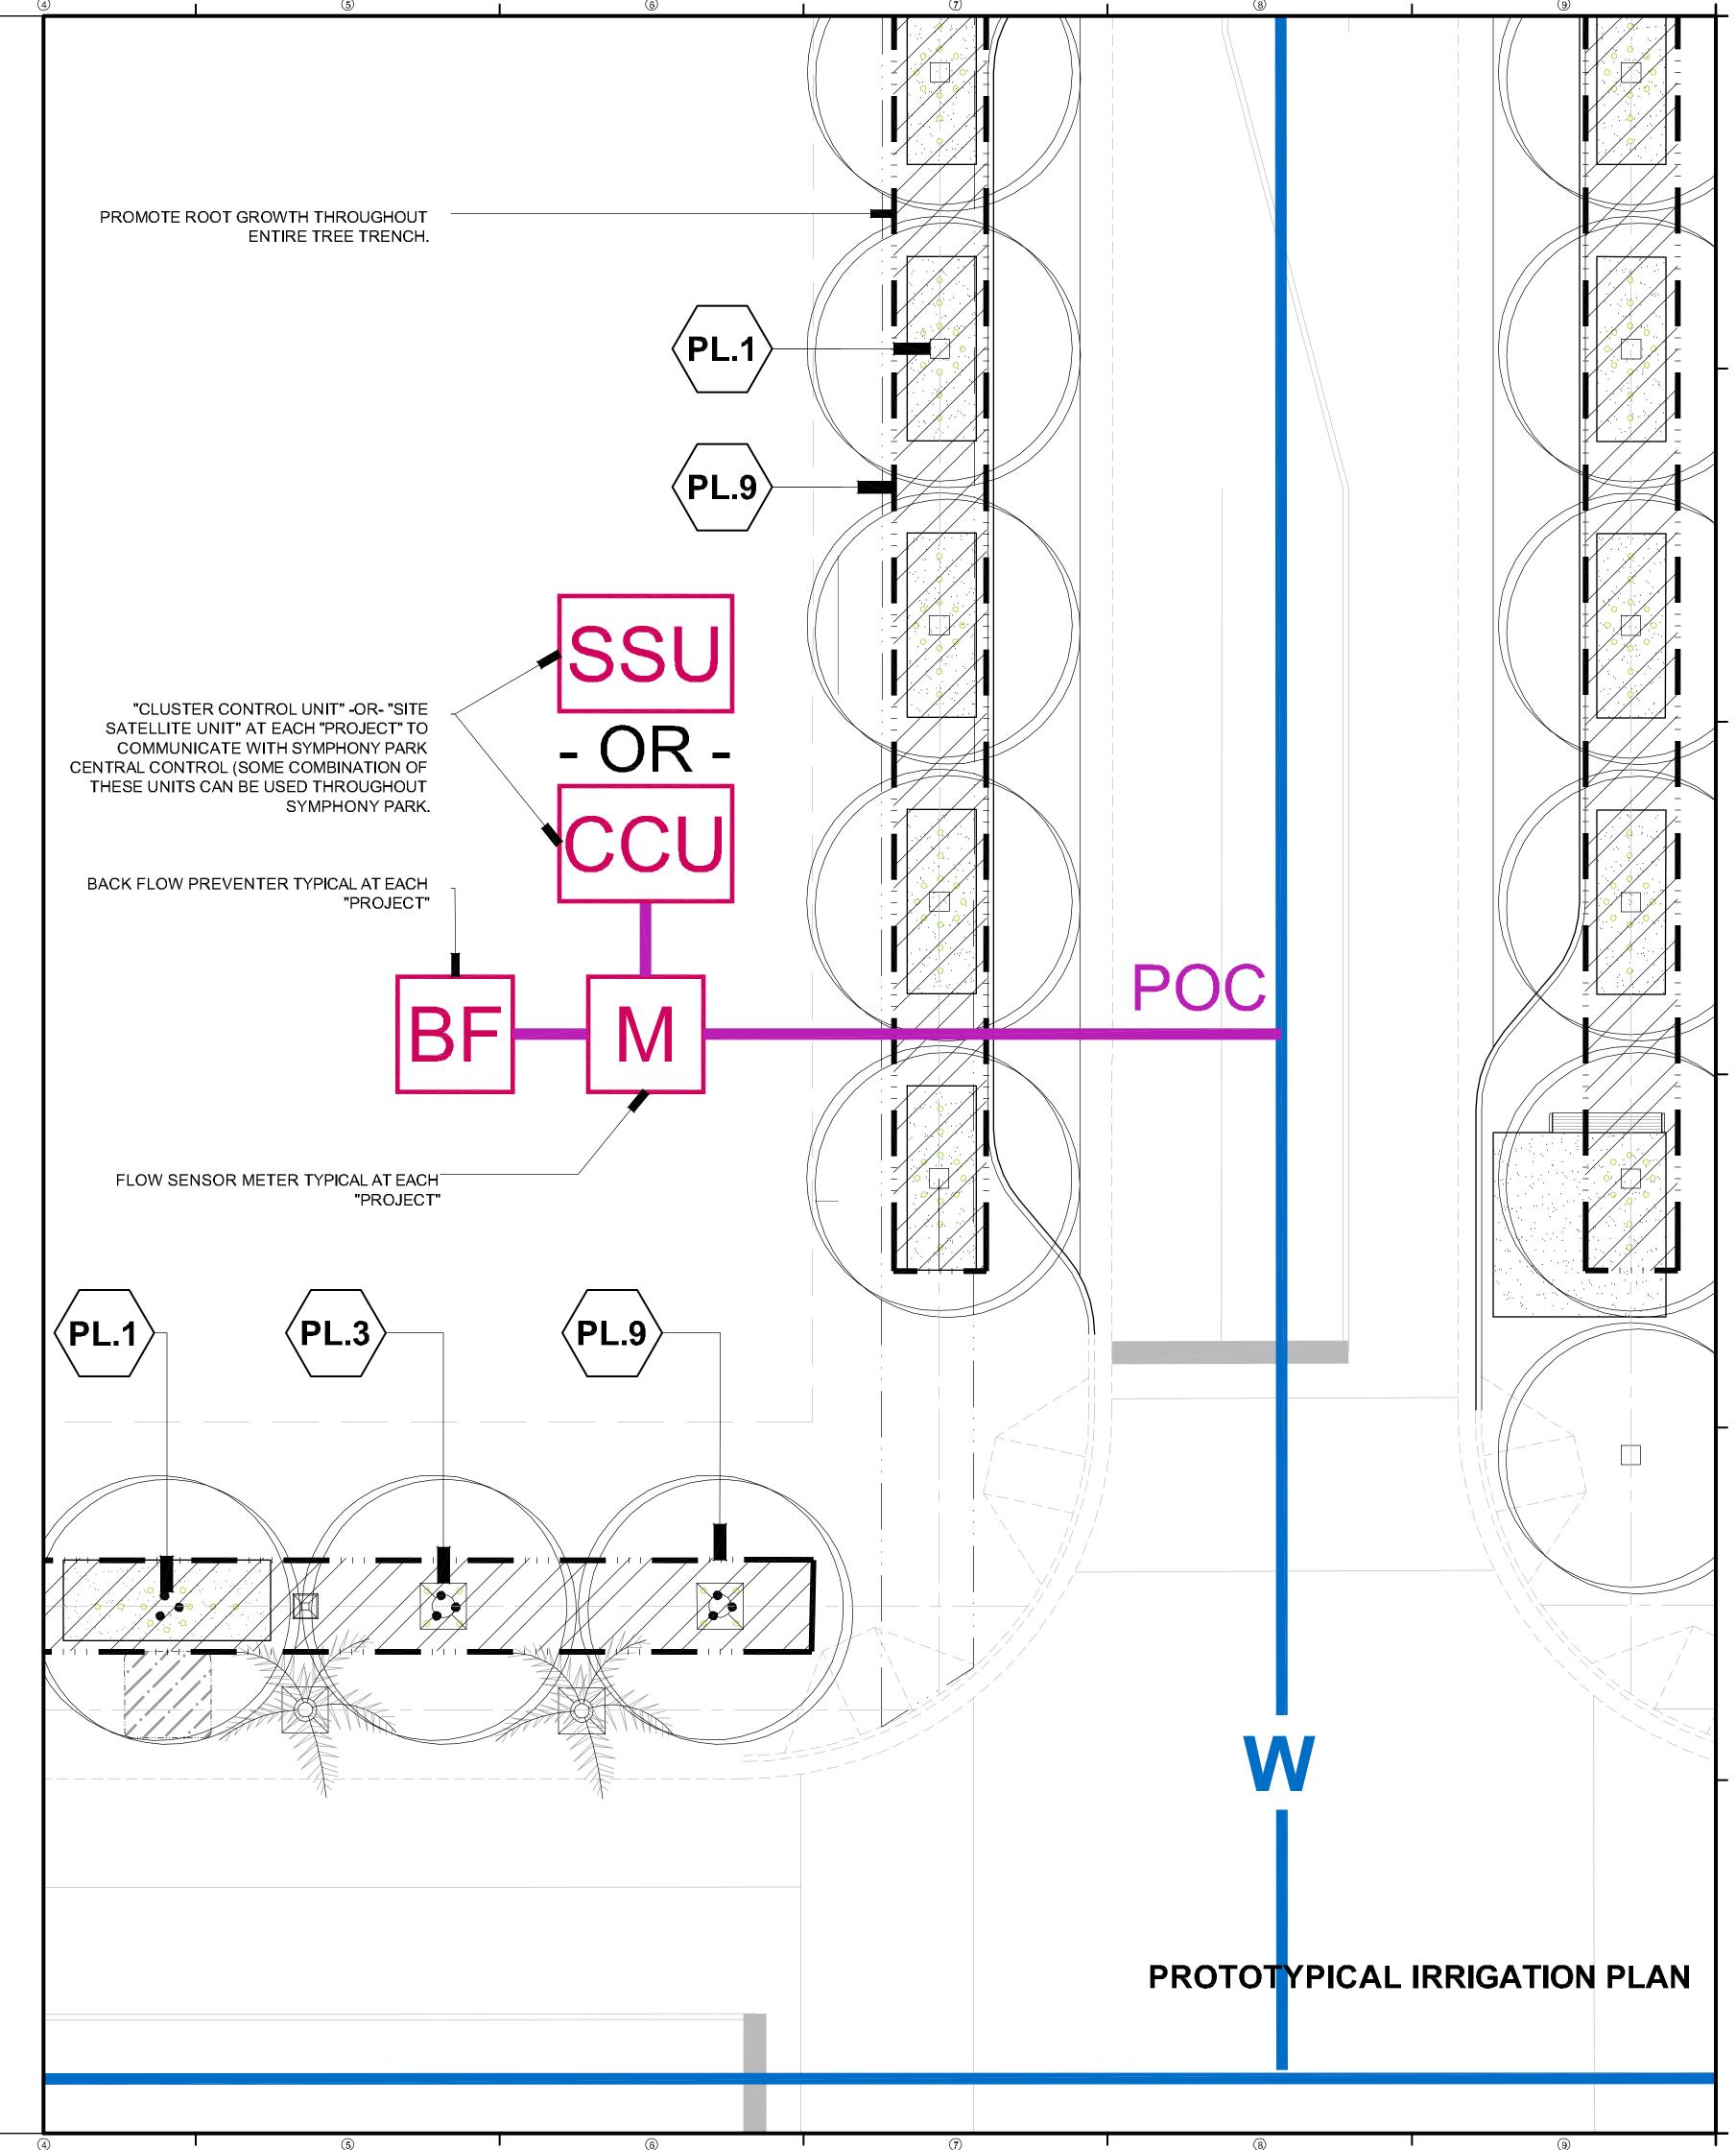

#### CITY OF LAS VEGAS

**NEWLAND COMMUNITIES** 

#### **DESIGN**WORKSHOP

Landscape Architecture • Land Planning
Urban Design • Tourism Planning

Asheville - Aspen - Austin - Denver
Phoenix - Salt Lake City - Tahoe

224 South 200 West Suite 150 Salt Lake City, Utah 84101

(801) 359-4771 Facsimile (801) 359-4411

W W W.D E S I G N W O R K S H O P.C O M

YMPHONY PARK

REETSCAPE SCHEMATIC DESIGN

ISSUE DATE: November 9, 2007

THIS PACKAGE REPRESENTS 100% SCHEMATIC STREETSCAPE DESIGN. THIS WORK IS CO-ORDINATED WITH AN IN-PROGRESS ENGINEERING BASE. THIS ENGINEERING BASE IS SUBJECT TO CHANGE AND REFINEMENTS DO TO CITY REVIEW. REVISIONS

# DATE DESCRIPTION
1 07/10/2007 PROMENADE CLEAR ZONE

 2
 09/07/2007
 PRIVATE STREET LIGHTING

 3
 09/07/2007
 PARCEL F/G PRIVATE ST.

 4
 14/09/2007
 STREET LIGHTS

 4
 11/09/2007
 STREET LIGHTS

 5
 01/08/2008
 FINAL EDITS

6 12/12/2008 SD NOTE ADDITION 7 06/05/2009 NAME REVISIONS

### SCHEMATIC DESIGN

PROJECT NUMBER: 4035

IRRIGATION INTENT

SHEET NUMBER

L3-02

#### **General Intent of Pedestrian Lighting**

#### Ambiance

To set a mood, define character, quality, tone and atmosphere appropriate to uses of the space being lit.

#### Diversity of Experience

To create variation in the streetscape and definition of important or different areas.

#### Safety

To provide adequate light where hazards and intersections exist, protecting the general health and welfare of the pubic.

#### Character

An element that is used to define the features and traits which form the individual nature of a place.

#### Scale

An element that creates spaces which feel comfortable to pedestrians and defines the edges of the pedestrian realm.

#### Continuity

The site wide master controller is to manage all streetscape lighting and irrigation throughout the entire Union Park project. All pedestrian lighting will be orchestrated from this main controller to bring a unified management approach to the entire Union Park streetscape.

#### **Assumptions**

#### Lighting Engineer

Individual Developers will hire a qualified lighting engineer to design the lighting plans for the Design Development and Consruction Documentation phases of the project

#### **Fixture**

Photometric studies, plan and section studies are based on the Louis Poulsen kastrup pedestrian light, 175 W., Metal Halide lamp. Note - the Kastrup cut-sheet indicates a 150 W lamp although available IES Photometric information from manufacturer only includes a 175 W version.


#### **Light Level Requirements**

A review of the Las Vegas Development Code indicate "The public areas and sidewalks should be designed to provide a minimum average of one foot-candle of light at ground level."

A thorough review of the Las Vegas Development Code, Las Vegas Urban Design Guidelines and Downtown Las Vegas Centennial Plan should be accomplished by a qualified lighting engineer prior to further design and documentation.

#### **Products**

Refer to product information on this sheet.

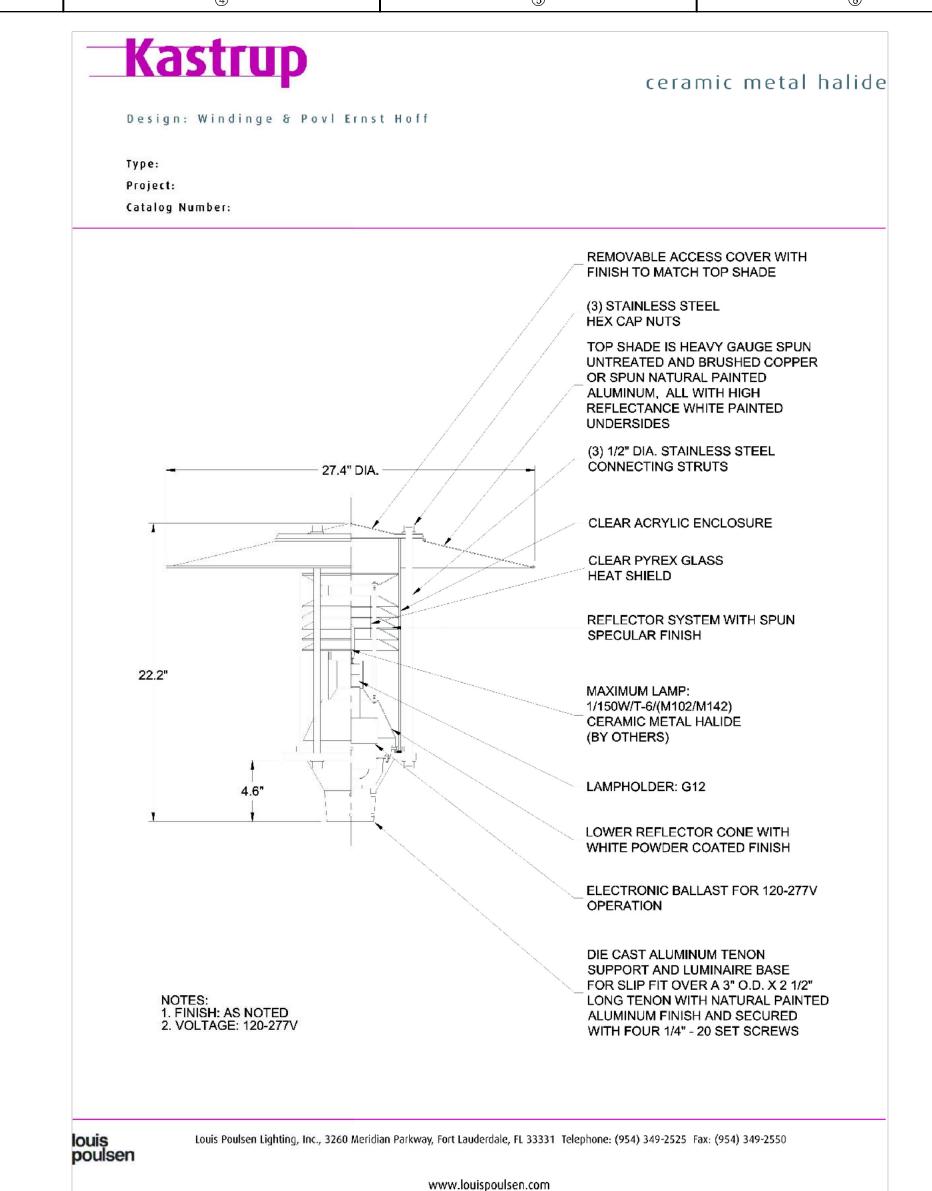





4'-0"

TYPICAL SECTION

1/4"= 1'-0"

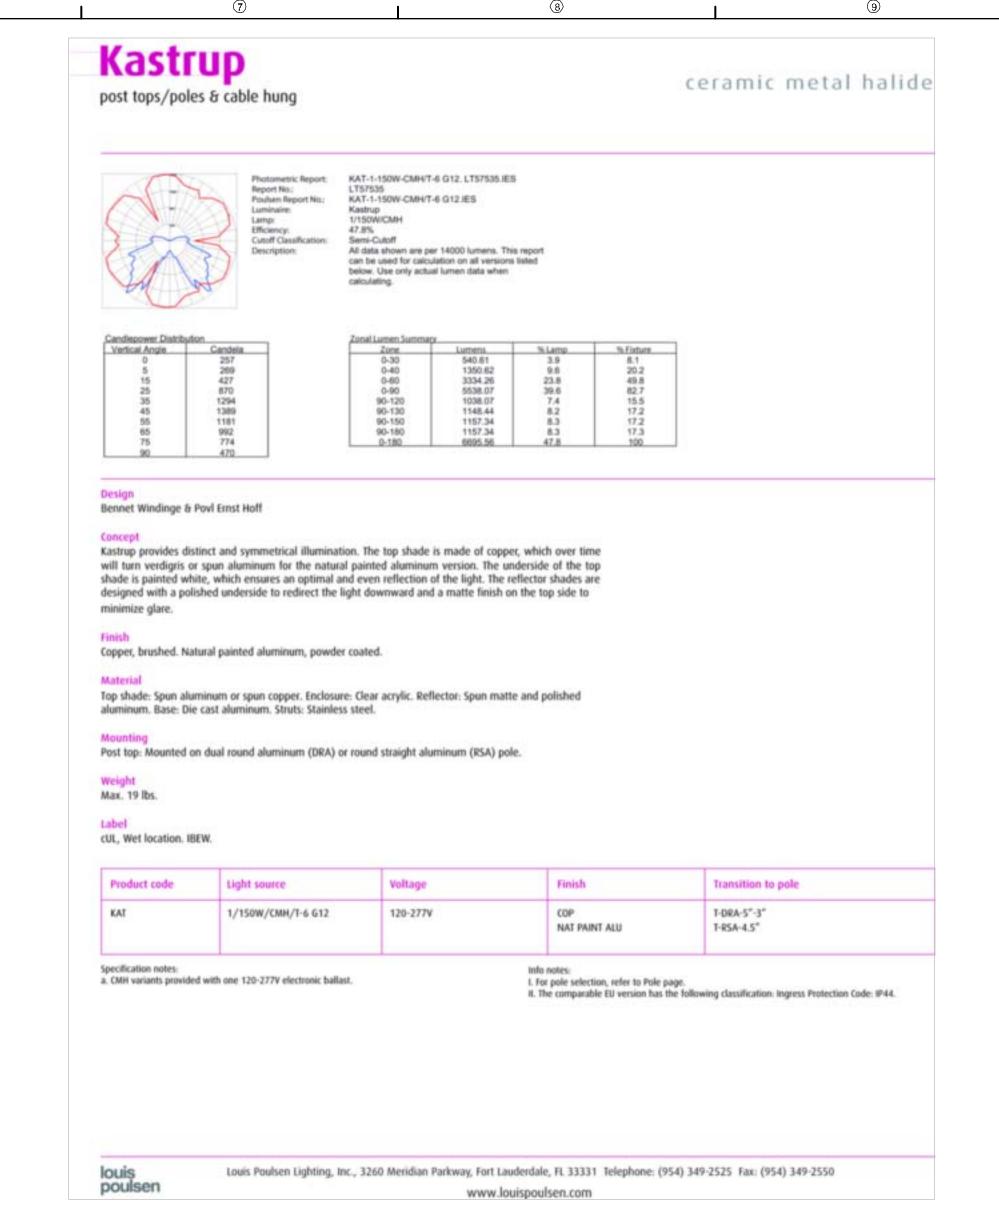

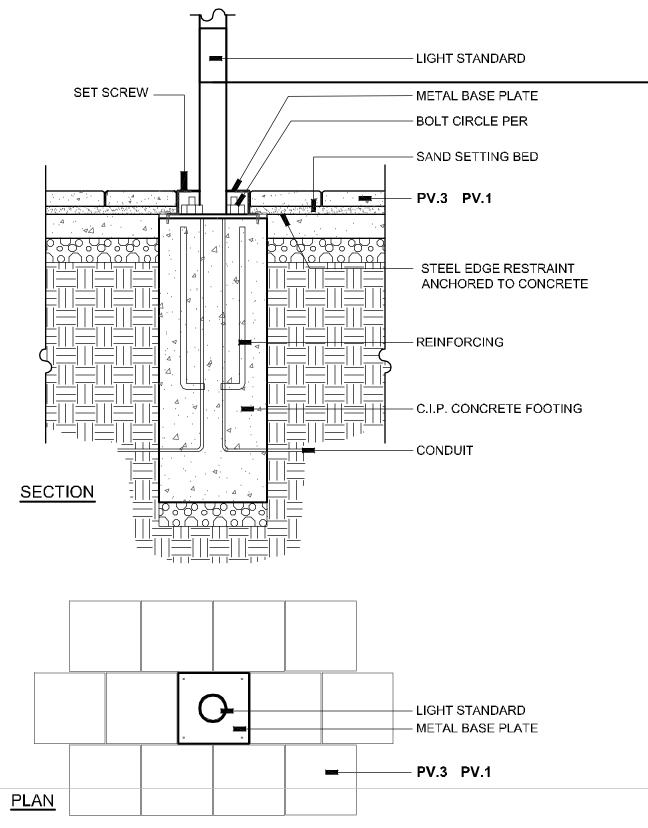

PEDESTRIAN LIGHT MOUNTING DETAIL

3/4"= 1'-0"

ISSUE DATE: November 9, 2007

STREETSCAPE DESIGN. THIS WORK IS CO-ORDINATED WITH AN IN-PROGRESS ENGINEERING BASE. THIS ENGINEERING BASE IS SUBJECT TO CHANGE AND REFINEMENTS DO TO CITY REVIEW REVISIONS

**CITY OF LAS VEGAS** 

**NEWLAND COMMUNITIES** 

**DESIGN**WORKSHOP

Landscape Architecture • Land Planning

Urban Design • Tourism Planning

Asheville - Aspen - Austin - Denver

Phoenix - Salt Lake City - Tahoe

224 South 200 West Suite 150 Salt Lake City, Utah 84101

(801) 359-4771

Facsimile (801) 359-4411

DE

W W W.D E S I G N W O R K S H O P.C O M

# DATE DESCRIPTION 1 07/10/2007 PROMENADE CLEAR ZONE 09/07/2007 PRIVATE STREET LIGHTING 09/07/2007 PARCEL F/G PRIVATE ST. 11/09/2007 STREET LIGHTS 5 01/08/2008 FINAL EDITS

6 12/12/2008 SD NOTE ADDITION

7 06/05/2009 NAME REVISIONS

SCHEMATIC

PROJECT NUMBER: 4035

DESIGN

LIGHTING INTENT PEDESTRIAN

> SHEET NUMBER L3-03

OCOPYRIGHT DESIGNWORKSHOP, INC.

#### **General Intent of Pedestrian Lighting**

#### Ambiance

To set a mood, define character, quality, tone and atmosphere appropriate to uses of the space being lit.

#### Safety

To provide adequate light where hazards and intersections exist, protecting the general health and welfare of the pubic.

#### Character

An element that is used to define the features and traits which form the individual nature of a place.

#### Scale

An element that creates spaces which feel comfortable to pedestrians and defines the edges of the pedestrian realm.

#### Continuity

The site wide master controller is to manage all streetscape lighting and irrigation throughout the entire Symphony Park project. All pedestrian lighting will be orchestrated from this main controller to bring a unified management approach to the entire Symphony Park streetscape.

#### **Assumptions**

Individual Developers will hire a qualified lighting engineer to design the lighting plans for the Design Development and Consruction Documentation phases of the project


#### **Light Level Requirements**

A review of the Las Vegas Development Code indicate "The public areas and sidewalks should be designed to provide a minimum average of one foot-candle of light at ground level."

A thorough review of the Las Vegas Development Code, Las Vegas Urban Design Guidelines and Downtown Las Vegas Centennial Plan should be accomplished by a qualified lighting engineer prior to further design and documentation


#### **Products**

All Visio and Hellux products to be aluminum and stainless steel only. No painted products. For more detail refer to product information on this sheet.

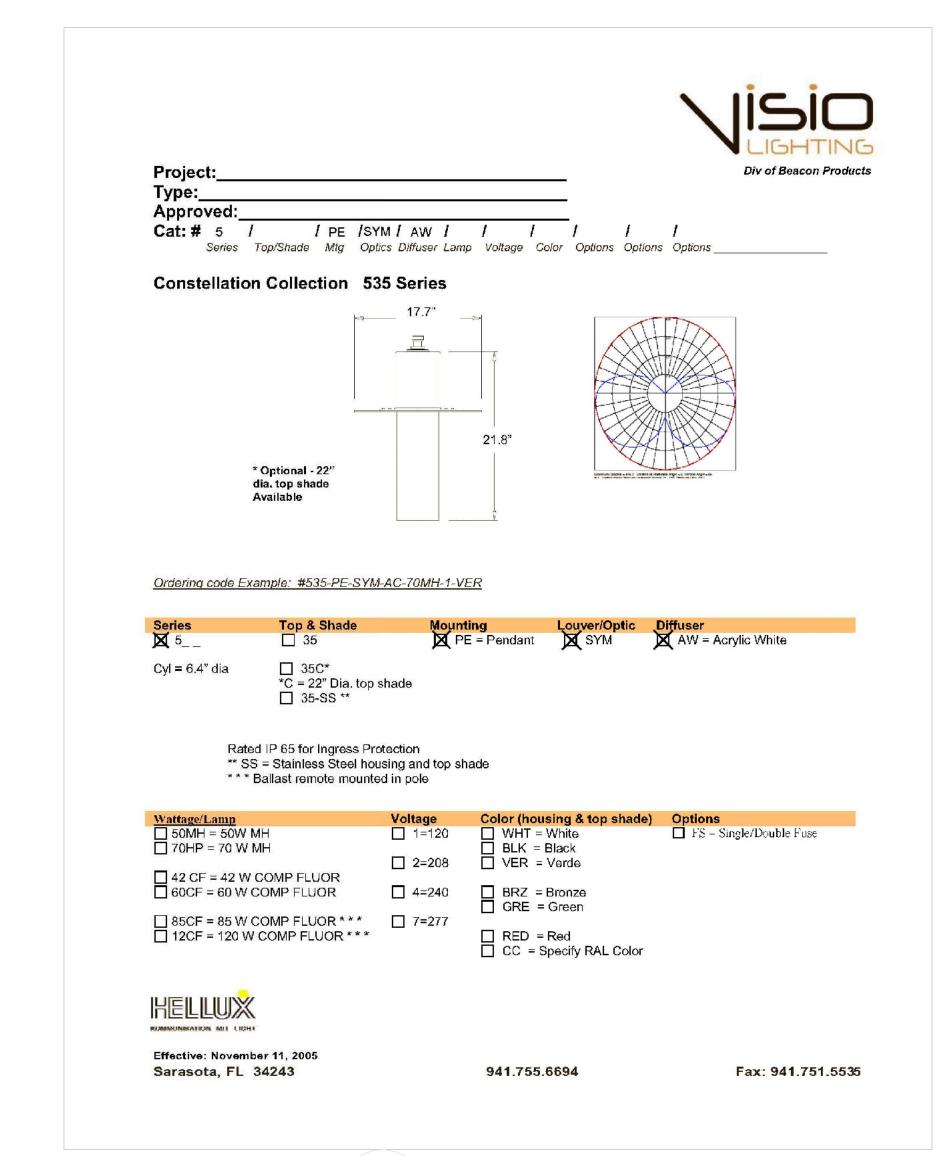

1/4"= 1'-0"



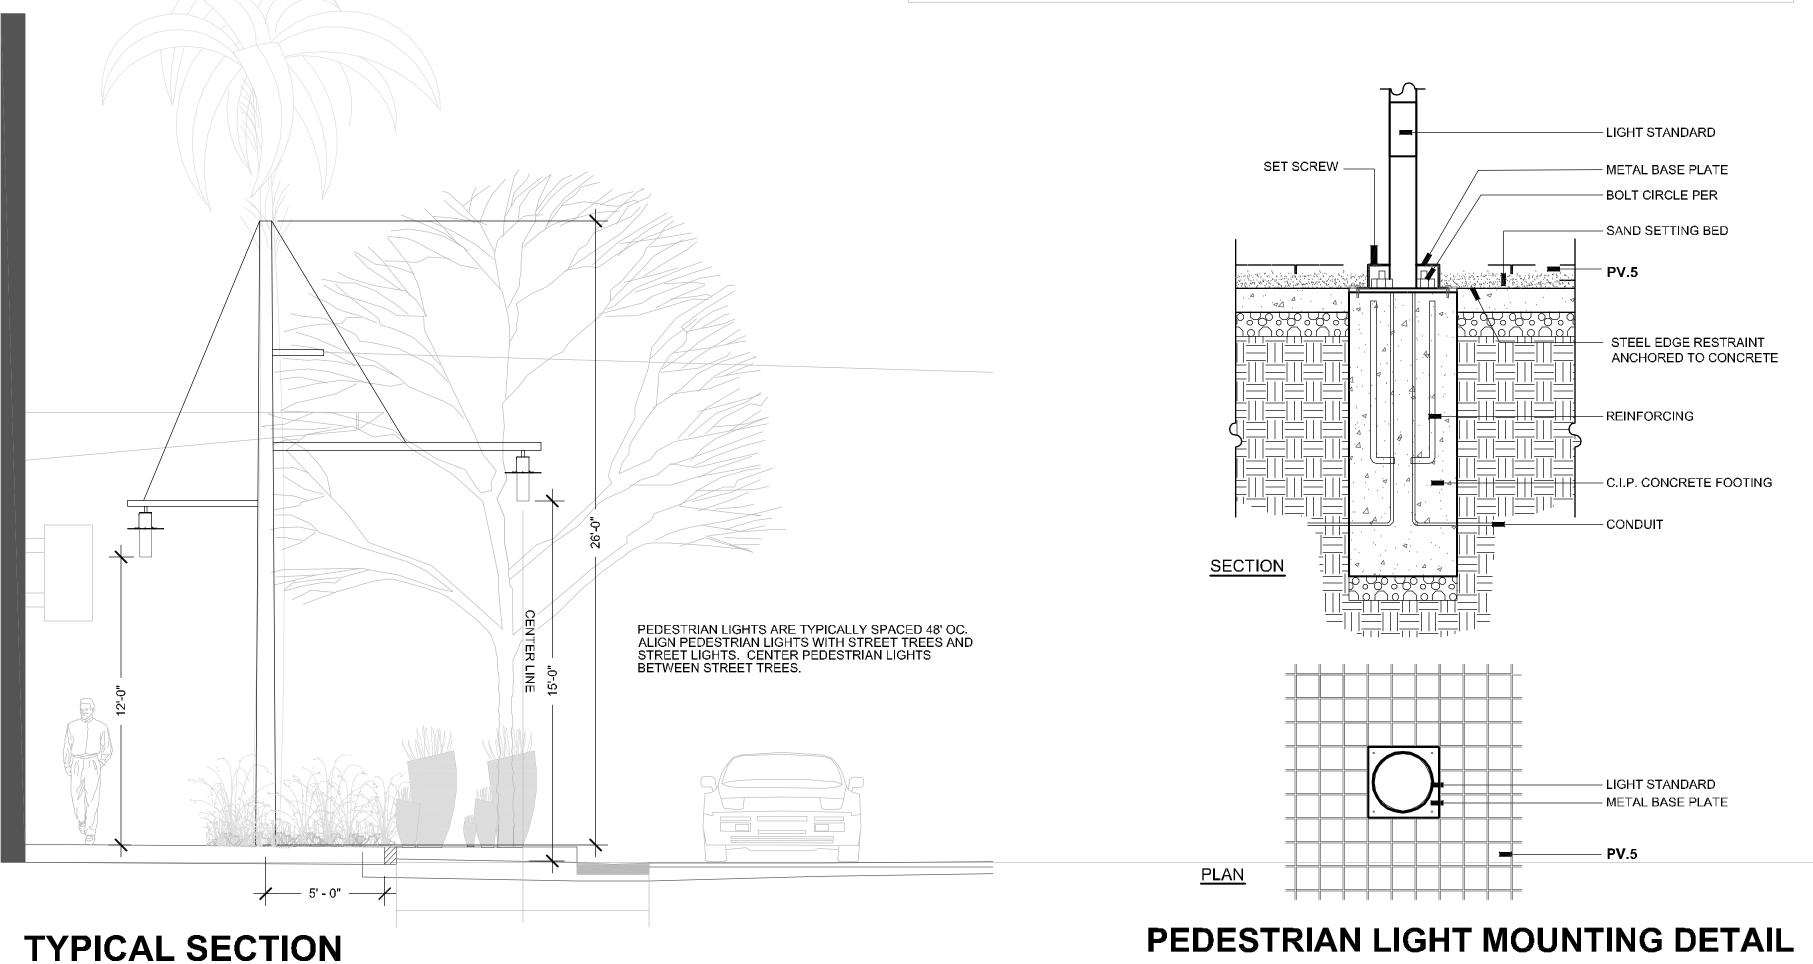

3/4"= 1'-0"

#### CITY OF LAS VEGAS

#### **NEWLAND COMMUNITIES**

#### DESIGNWORKSHOP

Landscape Architecture • Land Planning
Urban Design • Tourism Planning

Asheville - Aspen - Austin - Denver Phoenix - Salt Lake City - Tahoe

224 South 200 West Suite 150 Salt Lake City, Utah 84101 (801) 359-4771

Facsimile (801) 359-4411

W W W.D E S I G N W O R K S H O P.C O M

APHONY PARK

ETSCAPE SCHEMATIC DESIGN

ISSUE DATE: November 9, 2007

THIS PACKAGE REPRESENTS 100% SCHEMATIC STREETSCAPE DESIGN. THIS WORK IS CO-ORDINATED WITH AN IN-PROGRESS ENGINEERING BASE. THIS ENGINEERING BASE IS SUBJECT TO CHANGE AND REFINEMENTS DO TO CITY REVIEW. REVISIONS

# DATE DESCRIPTION

 1
 07/10/2007
 PROMENADE CLEAR ZONE

 2
 09/07/2007
 PRIVATE STREET LIGHTING

 3
 09/07/2007
 PARCEL F/G PRIVATE ST.

5 09/07/2007 PARCEL F/G PRIV 4 11/09/2007 STREET LIGHTS 5 01/08/2008 FINAL EDITS

6 12/12/2008 SD NOTE ADDITION
7 06/05/2009 NAME REVISIONS


### SCHEMATIC DESIGN


PROJECT NUMBER: 4035

### LIGHTING INTENT PROMENADE

SHEET NUMBER

O COPYRIGHT DESIGNWORKSHOP, INC.

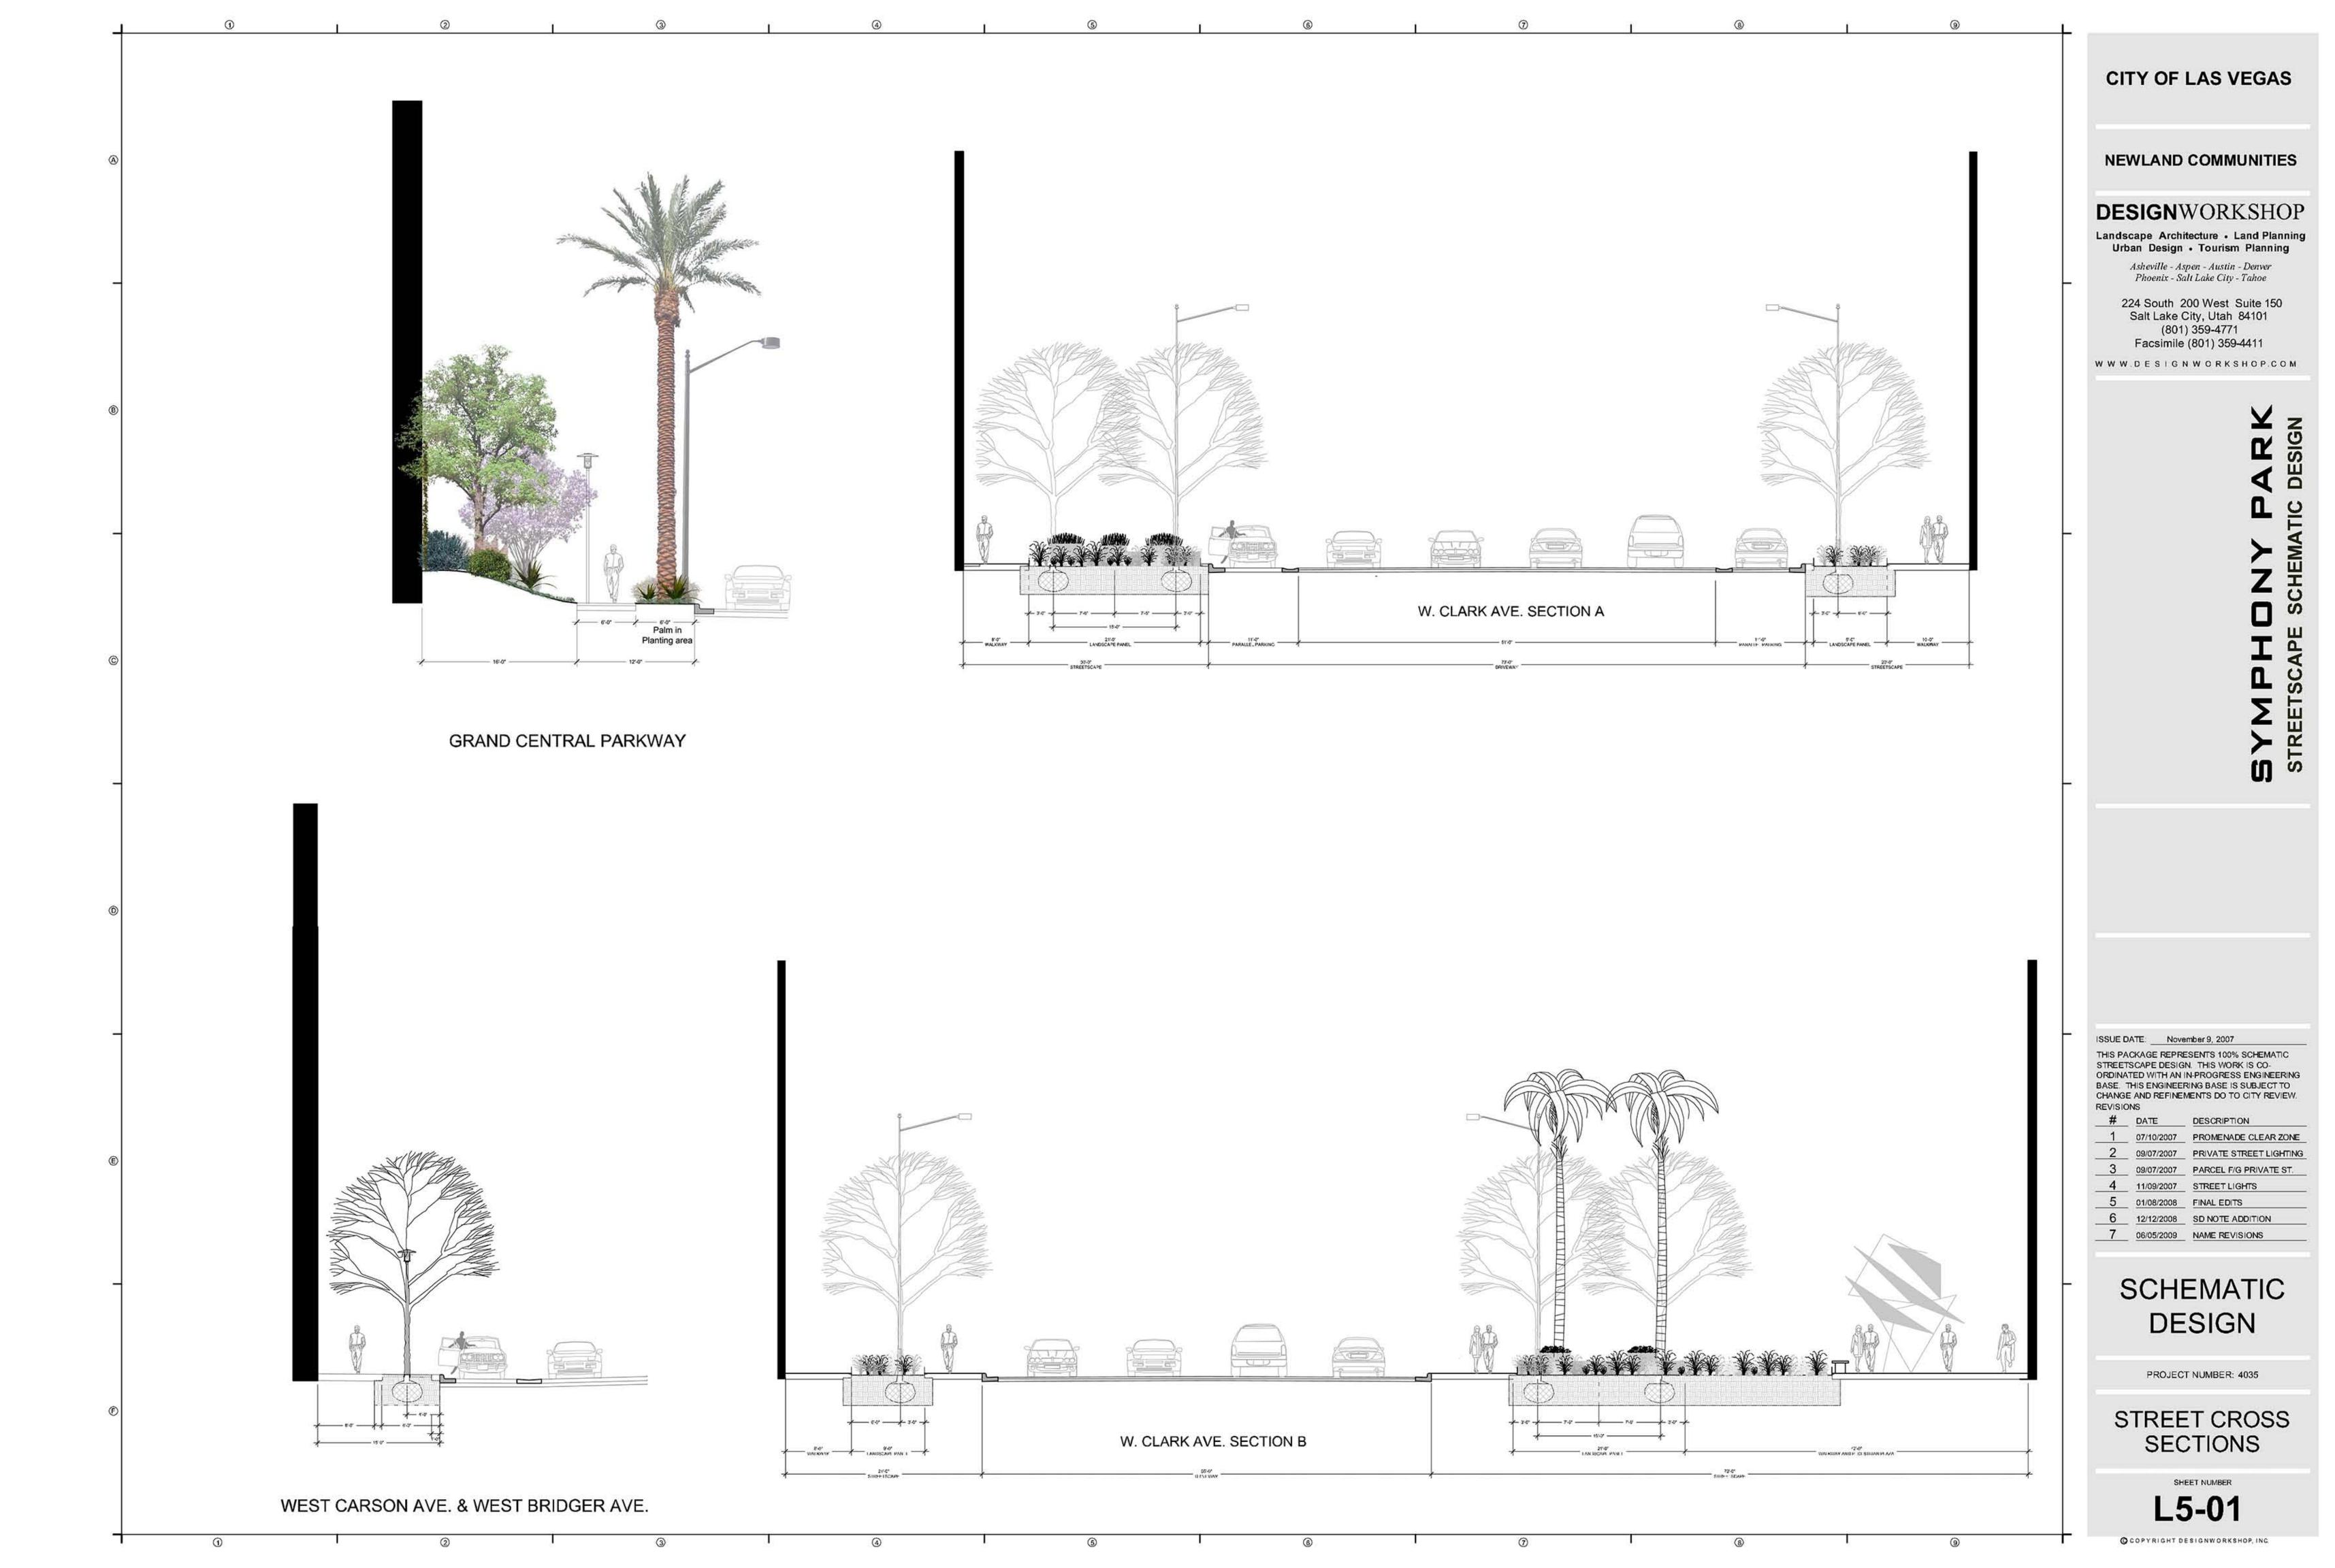


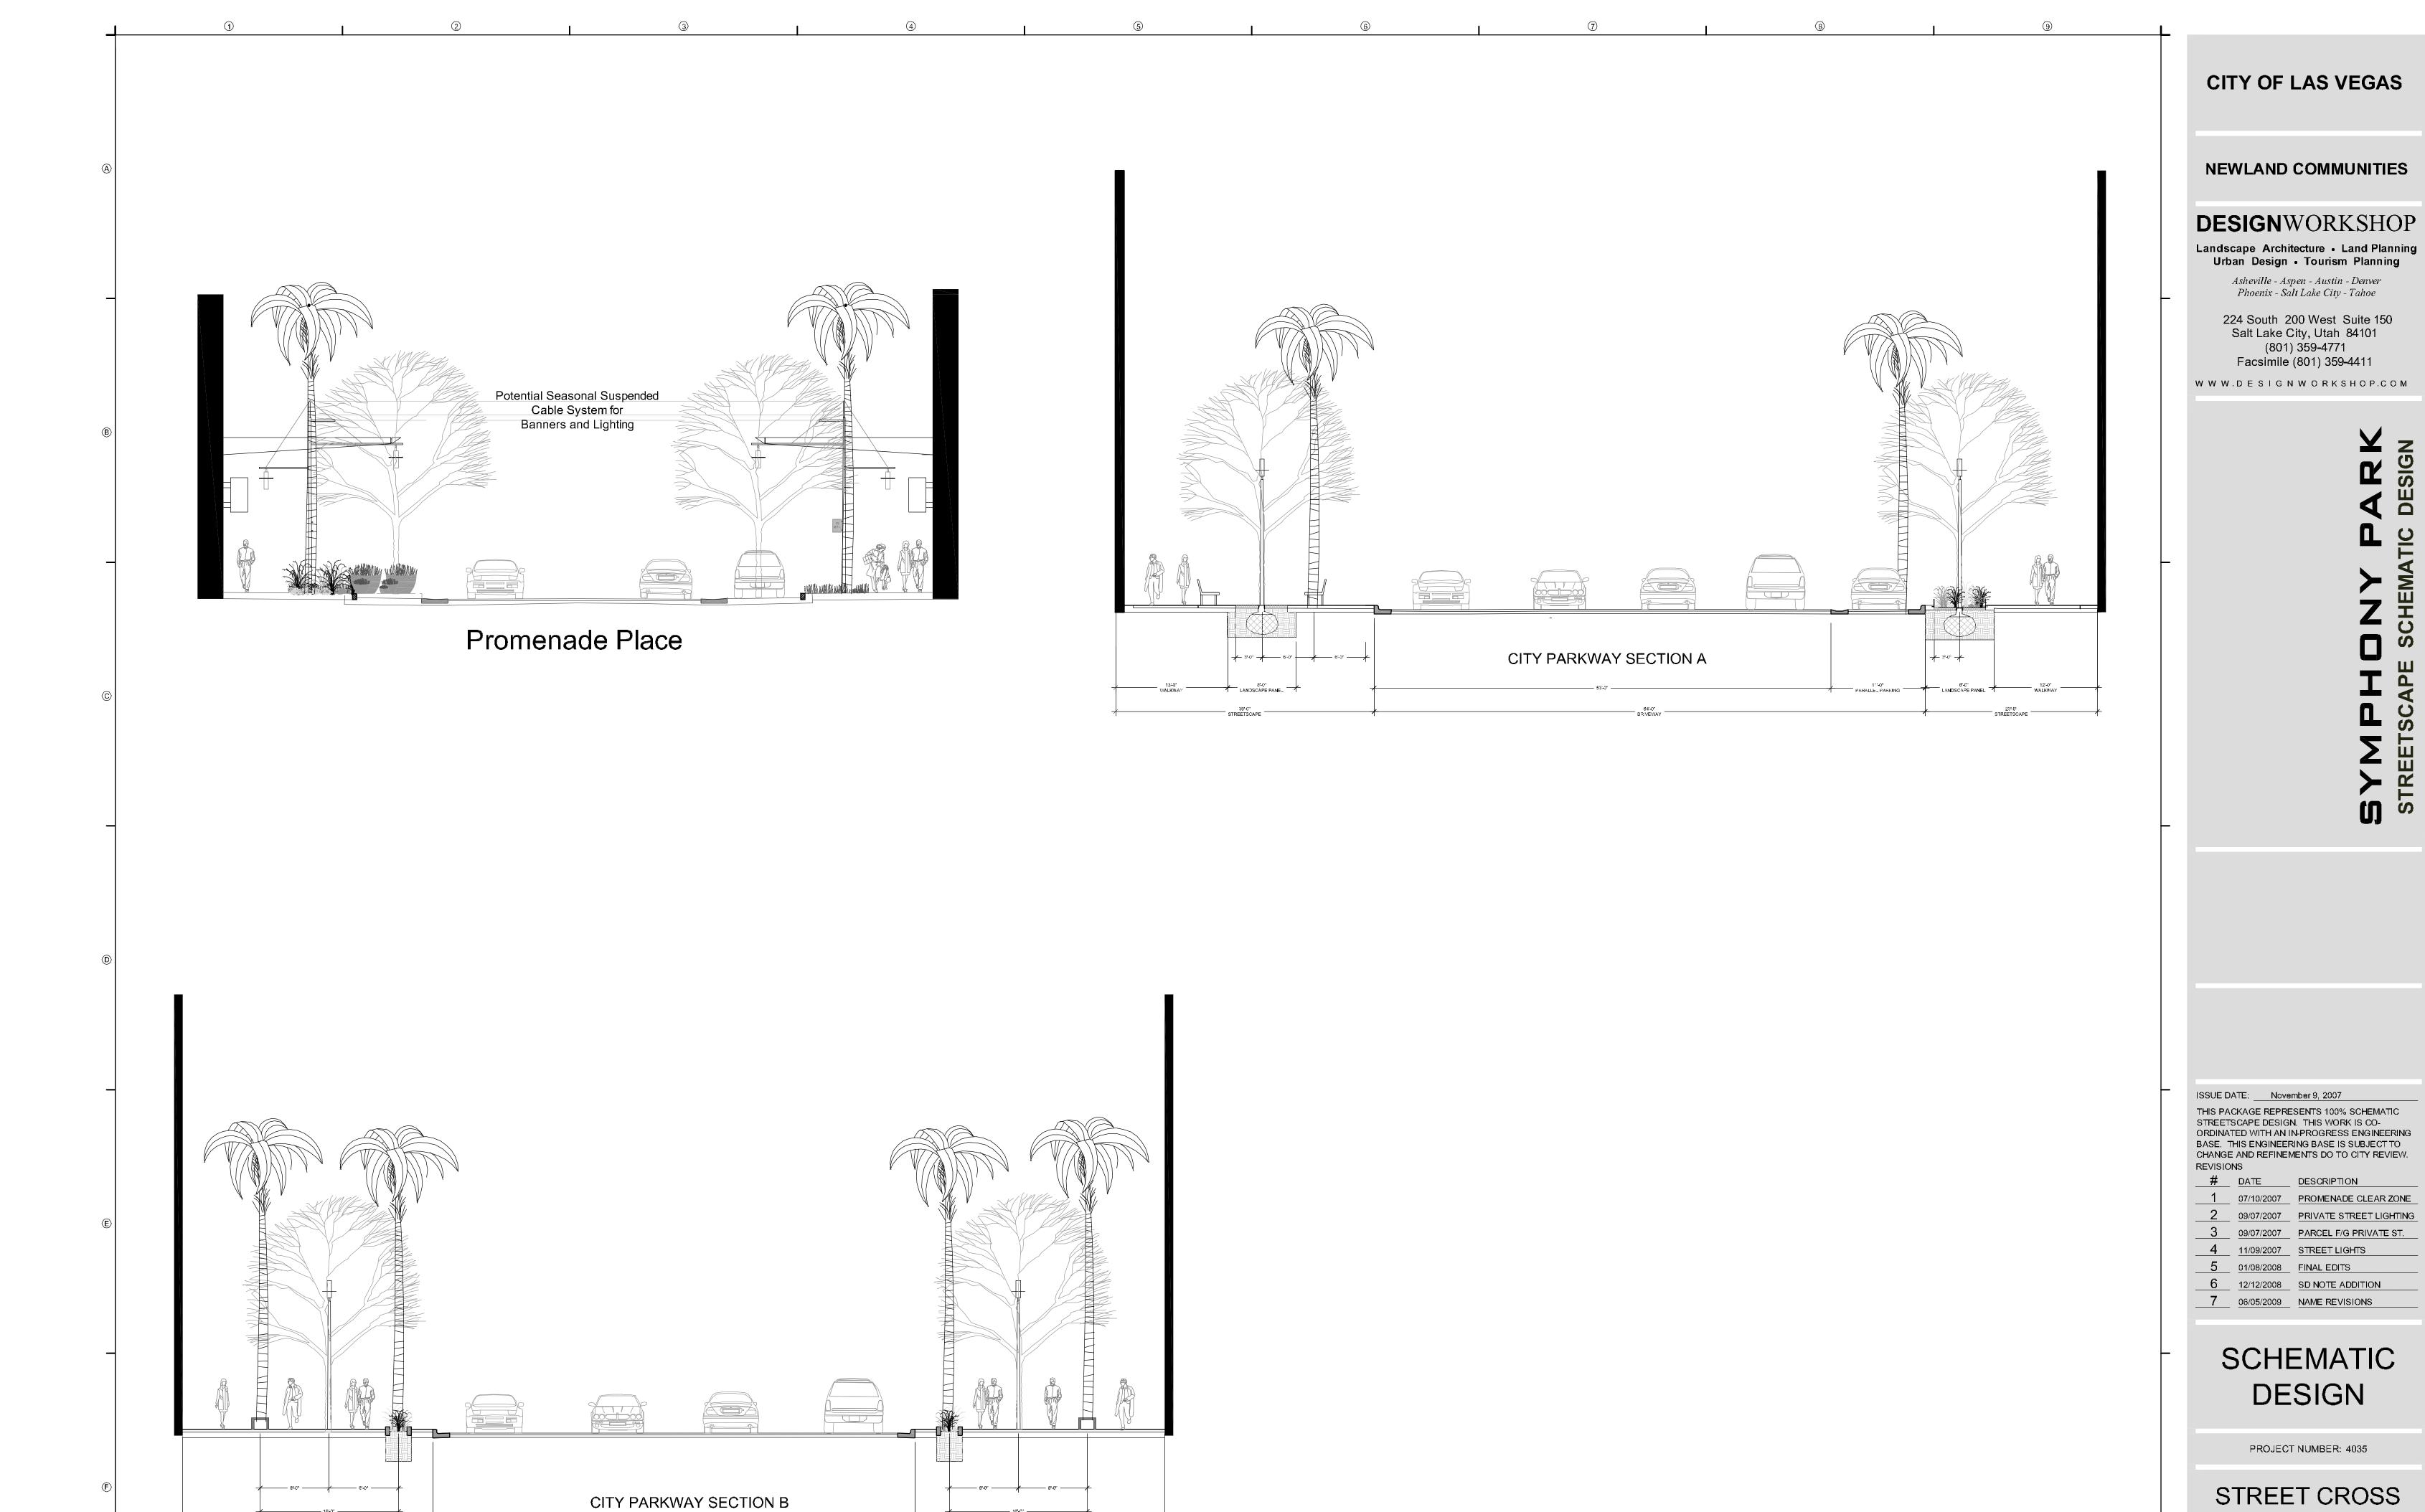

SECTIONS

SHEET NUMBER

L5-02

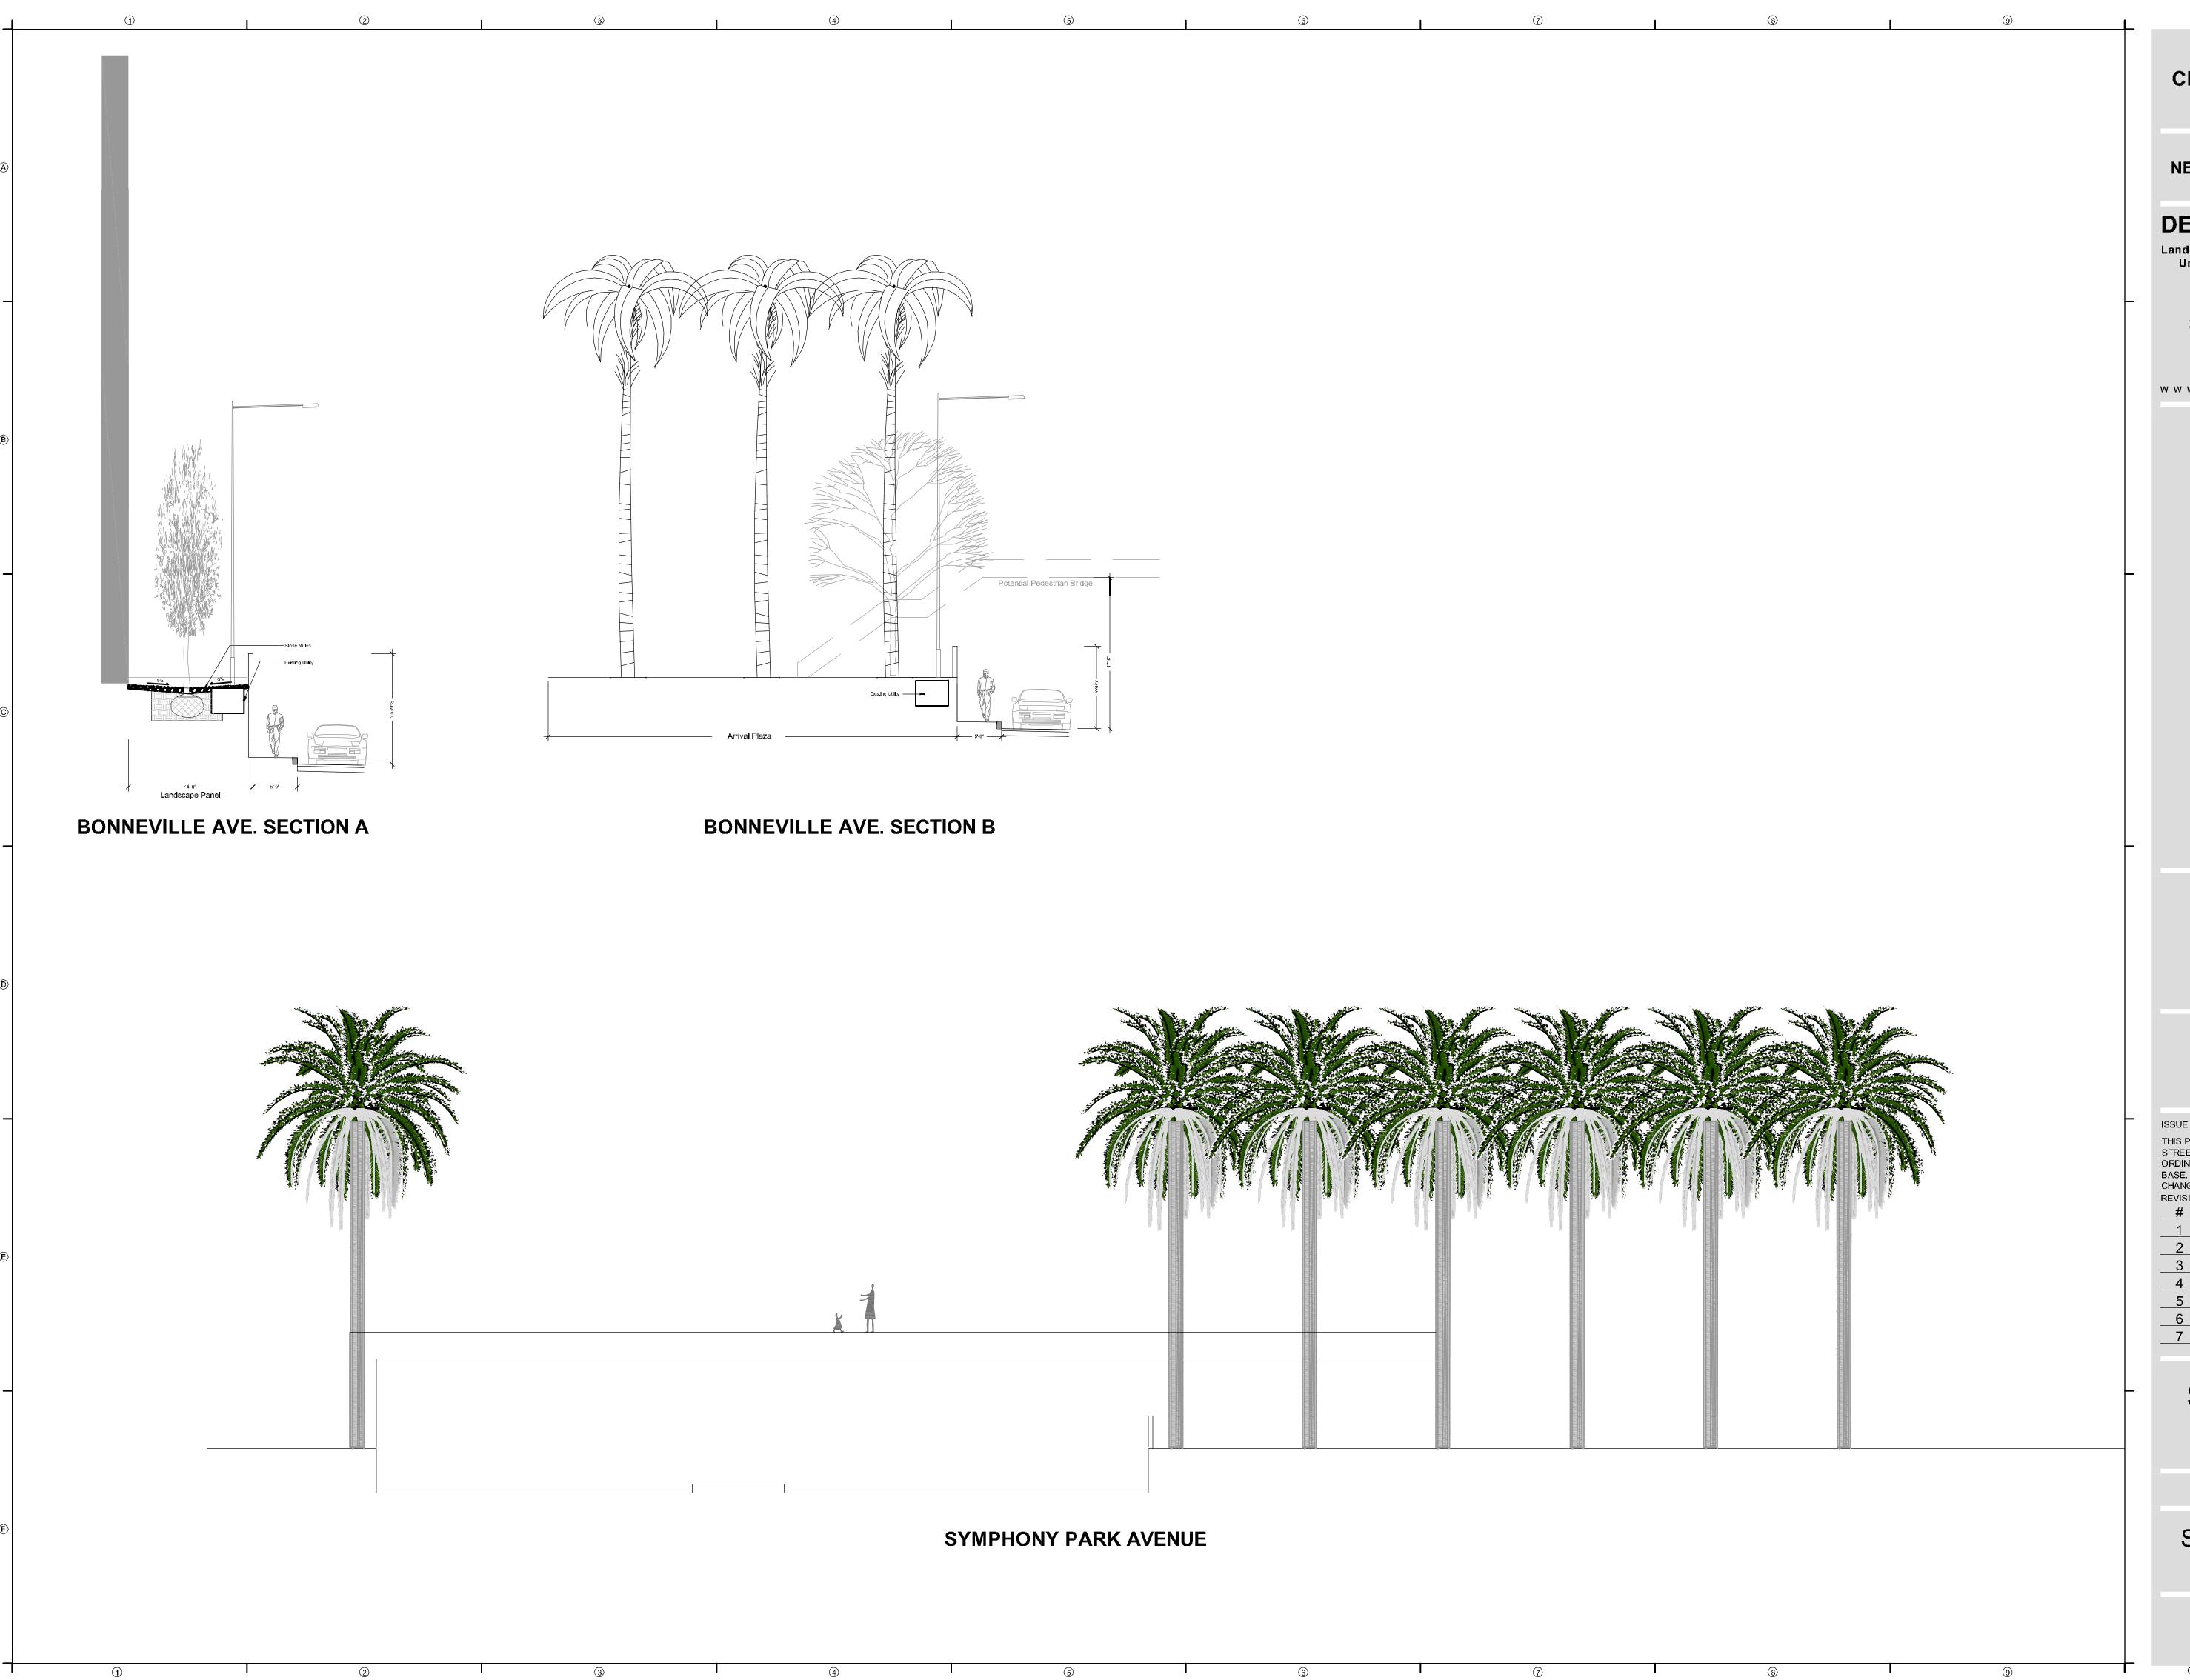

**NEWLAND COMMUNITIES** 

DESIGNWORKSHOP

Landscape Architecture • Land Planning
Urban Design • Tourism Planning

Asheville - Aspen - Austin - Denver Phoenix - Salt Lake City - Tahoe

224 South 200 West Suite 150 Salt Lake City, Utah 84101 (801) 359-4771 Facsimile (801) 359-4411

W W W.D E S I G N W O R K S H O P.C O M

TREETSCAPE SCHEMATIC DESIGN

ISSUE DATE: November 9, 2007

THIS PACKAGE REPRESENTS 100% SCHEMATIC STREETSCAPE DESIGN. THIS WORK IS CO-ORDINATED WITH AN IN-PROGRESS ENGINEERING BASE. THIS ENGINEERING BASE IS SUBJECT TO CHANGE AND REFINEMENTS DO TO CITY REVIEW. REVISIONS

 #
 DATE
 DESCRIPTION

 1
 07/10/2007
 PROMENADE CLEAR ZONE

 2
 09/07/2007
 PRIVATE STREET LIGHTING

 3
 09/07/2007
 PARCEL F/G PRIVATE ST.

4 11/09/2007 STREET LIGHTS
5 01/08/2008 FINAL EDITS

6 12/12/2008 SD NOTE ADDITION
7 06/05/2009 NAME REVISIONS

SCHEMATIC DESIGN

PROJECT NUMBER: 4035

STREET CROSS SECTIONS